



GENERAL:

### DESCRIPTION OF WORK

THIS WORK INVOLVES REMOVAL OF APPROXIMATELY EXISTING RIPRAP AND CONSTRUCTION DEBRIS, FINAL SITE GRADING, REVEGETATION, AND LWD DEBRIS RESTORATION OVER APPROXIMATELY 850' OF ALA SPIT.

**ADDITIONAL CONTRACT WORK SHALL INCLUDE, BUT IS NOT LIMITED TO, THE FOLLOWING**

1. DEVELOPMENT OF SUBMITTALS INCLUDING A WORK PLAN, TEMPORARY EROSION AND SEDIMENT CONTROL PLAN (TESC), SPILL PREVENTION AND CONTAINMENT CONTROL PLAN, DEWATERING AND WATER MANAGEMENT PLAN, PROGRESS SCHEDULE, AND IMPORT MATERIAL SOURCES.
2. SITE CONTROL, INCLUDING ESTABLISHMENT OF SURVEY CONTROL, TEMPORARY BENCHMARKS, STAKING OF CLEARING LIMITS AND GRADING AREAS, STAGING AREAS, SECURITY MEASURES, AND OTHER AS NECESSARY.
3. STRIPPING AND TEMPORARY ACCESS, INCLUDING IMPROVEMENT OF STAGING AND STOCKPILE AREAS, LIMITED CLEARING, SALVAGE OF VEGETATION, GRUBBING AND STOCKPILING OF SURFICIAL SOILS. ALSO INCLUDES TEMPORARY STORAGE OF SALVAGED VEGETATION TO BE REPLACED FOR SEED BANK OR REPLANTED BY OWNER (ISLAND COUNTY).
4. SITE CLEANUP AND RESTORATION INCLUDING REMOVAL OF TEMPORARY FACILITIES, STOCKPILES, TEMPORARY EROSION AND SEDIMENT CONTROLS, SPILL PREVENTION AND CONTAINMENT CONTROLS, AND WORK LIMITS FENCING.
5. PROJECT CLOSEOUT DOCUMENTATION INCLUDING SUBMITTAL OF FINAL AS-BUILT DRAWINGS, PAY REQUESTS, AND OTHER REQUIRED DOCUMENTATION.

## MINIMIZATION OF ENVIRONMENTAL IMPACT

EVERY REASONABLE EFFORT SHALL BE MADE TO PERFORM THE CONSTRUCTION IN A MANNER THAT PRESERVES WATER QUALITY AND FISH AND WILDLIFE HABITAT; INCLUDING BUT NOT LIMITED TO MIGRATORY WATERFOWL BREEDING AREAS, FORAGE FISH SPAWNING AREAS, AND AQUATIC RESOURCE BUFFER ZONES.

## WORK WINDOWS

CONSTRUCTION SHALL OCCUR BETWEEN (DATE - DATE) OR AS SPECIFIED IN THE WASHINGTON DEPARTMENT OF FISH AND WILDLIFE HYDRAULICS PERMIT.

## ENGINEER

THE ENGINEER SHALL BE A DESIGNATED REPRESENTATIVE OF CLIENT. ALL COMMUNICATIONS THAT REQUIRE INPUT FROM OR APPROVAL BY THE ENGINEER SHALL BE DIRECTED TO THIS REPRESENTATIVE. THE CLIENT RESERVES THE RIGHT TO CHANGE DESIGNATED REPRESENTATIVES DURING THE COURSE OF THE PROJECT.

## PERMITS

THE CONTRACTOR SHALL COORDINATE WITH THE CLIENT FOR ALL APPLICABLE PERMITS.

### SITE PREPARATION:

SITE PREPARATION WILL INCLUDE BUT IS NOT LIMITED TO FLAGGING BOUNDARIES OF PROTECTED AREAS, CONSTRUCTION AREAS, MATERIALS AND EQUIPMENT STORAGE AREAS AND CONSTRUCTION OF SEDIMENT BARRIERS (SILT FENCE). EXPECTED IMPACTS INCLUDE THE REMOVAL OF VEGETATION AND CLEARING OF GROUND COVER. CONSERVATION MEASURES WILL INCLUDE IMPLEMENTING A TEMPORARY EROSION AND SEDIMENT CONTROL (TESC) PLAN, MINIMIZING USE OF HEAVY EQUIPMENT, AND MAINTAINING CLEAN WEED AND PEST FREE EQUIPMENT.

## SOIL EROSION AND SEDIMENT CONTROLS

THE CONTRACTOR SHALL IMPLEMENT AND MAINTAIN APPROPRIATE EROSION AND SEDIMENT CONTROLS. THE WORK SHALL INCLUDE REMOVAL OF ALL INSTALLED CONTROLS AT PROJECT CLOSE. APPROVAL FOR REMOVAL OF CONTROLS SHALL COME FROM THE CLIENT FOR AREAS ABOVE THE MEAN HIGHER HIGH WATER (MHHW).

### SITE WORK:

## BEST MANAGEMENT PRACTICES (BMPS)

THE FOLLOWING BMPS SHALL BE IMPLEMENTED DURING ALL RESTORATION ACTIVITIES:

- INSTALLATION OF SEDIMENT/EROSION CONTROL DEVICES INCLUDING SILT FENCE, BALES, ETC. PRIOR TO CONSTRUCTION.
- LIMITATION OF USE OF HEAVY EQUIPMENT, MAINTENANCE OF CLEAN EQUIPMENT, AND LIMITATION OF ACTIVITIES BELOW THE MHHW.
- IMPLEMENTATION OF SPILL PREVENTION AND CONTAINMENT PLAN (MINIMIZE SPILLAGE OF FUEL/OIL LEAKAGE FROM EQUIPMENT).
- ALL EQUIPMENT SHALL USE BIODEGRADABLE HYDRAULIC FLUID

### SUBMITTALS:

THE FOLLOWING SHALL BE SUBMITTED TO THE ENGINEER PRIOR TO THE START OF WORK AND DURING THE COURSE OF THE WORK. THE PURPOSE OF THE SUBMITTAL REVIEW IS TO VERIFY THAT APPLICABLE REGULATORY AND PERMIT REQUIREMENTS ARE MET AND THAT PERFORMANCE REQUIREMENTS ARE ENSURED.

1. PRIOR TO STARTING WORK, THE CONTRACTOR SHALL SUBMIT A WATER QUALITY CONTROL PLAN THAT DESCRIBES MEANS AND METHODS TO MEET CRITERIA AND PERFORMANCE REQUIREMENTS DESCRIBED AND/OR SHOWN ON THE DRAWINGS. CONTRACTOR SHALL ALSO INCLUDE A TEMPORARY EROSION AND SEDIMENT CONTROL (TESC) PLAN. INCLUDE A MARKED UP VERSION (HAND MARKED IS ACCEPTABLE) OF THE CONSTRUCTION PLAN SET TO SHOW LIMITS OF CONTROLS, STAGING AREAS TO BE UTILIZED WITHIN THE PROJECT LIMITS, AND ANY VARIANCES TO THE REQUIREMENTS SHOWN OR DESCRIBED IN THESE DRAWINGS. THE ENGINEER MUST APPROVE THE WATER QUALITY CONTROL PLAN AND TESC PLAN PRIOR TO STARTING WORK.
2. PRIOR TO STARTING WORK, THE CONTRACTOR SHALL SUBMIT A SPILL PREVENTION AND CONTAINMENT PLAN THAT DESCRIBES MEANS AND METHODS FOR PREVENTING AND CONTAINING ANY SPILLS OR RELEASES TO THE ENVIRONMENT DURING THE COURSE OF THE WORK. THE ENGINEER MUST APPROVE THE SPILL PREVENTION AND CONTAINMENT PLAN PRIOR TO STARTING WORK.
3. PRIOR TO STARTING WORK, THE CONTRACTOR SHALL SUBMIT A CONSTRUCTION SCHEDULE THAT DETAILS THE SEQUENCING OF THE WORK. THE ENGINEER MUST APPROVE THE SCHEDULE PRIOR TO STARTING WORK.
4. CONTRACTOR SHALL SUBMIT, PRIOR TO ACCEPTANCE AND PLACEMENT, MATERIAL DATA SHEETS FOR FILL MATERIALS INDICATING CONFORMANCE WITH THE REQUIREMENTS SET FORTH ON THE DRAWINGS. MATERIALS THAT DO NOT MEET THE REFERENCED SPECIFICATIONS SHALL NOT BE ALLOWED AT THE PROJECT SITE.

SEQUENCE OF CONSTRUCTION:

THE SEQUENCE OF WORK WILL BE IN ACCORDANCE WITH THE CONSTRUCTION SCHEDULE SUBMITTED BY THE CONTRACTOR AND APPROVED BY THE ENGINEER. THE CONSTRUCTION SCHEDULE SHALL BE UPDATED ON A WEEKLY BASIS AND BE APPROVED BY THE ENGINEER EACH TIME THERE IS A CHANGE IN THE SCHEDULE. THE CONSTRUCTION SCHEDULE SHALL BE BASED ON THE REQUIREMENTS OF THESE CONTRACT DOCUMENTS, THE PROPOSED SEQUENCE PLAN SHOWN ON THE DRAWINGS, AND THE CONTRACTOR PREPARED AND OWNER-APPROVED DETAILED PLANS FOR THE WORK. THE WORK SHALL BE PERFORMED TO SATISFY THE PROJECT SEQUENCING REQUIREMENTS BELOW.

## CONSTRUCTION SEQUENCE

1. FLAG ALL RESTRICTED AREAS AND VEGETATION TO BE SALVAGED
2. INSTALL HIGH VISIBILITY FENCING
3. INSTALL ALL BMP'S AND TESC
4. CLEAR WOODY DEBRIS AS REQUIRED TO PROVIDE ACCESS
5. SALVAGE VEGETATION AND PLACE IN TEMPORARY NURSERY
6. SALVAGE RIPRAP FOR BULKHEAD EXTENSION AND REMOVE REMAINING CONSTRUCTION DEBRIS AND ROCK TO OFF SITE DISPOSAL FACILITY
7. REPLACE/EMBED SALVAGED DRIFT WOOD TO ORIGINAL EXTENTS AND FINISH GRADE DISTURBED AREAS
8. DECOMPACT SOIL AND PLACE SALVAGED SEED BANK VEGETATION TO ORIGINAL EXTENTS AND ELEVATION
9. REMOVE ALL BMP'S AND TESC'S


POST CONSTRUCTION:

## SITE RESTORATION

SITE RESTORATION FOLLOWING CONSTRUCTION SHALL INCLUDE LONG-TERM ESTABLISHMENT OF EROSION PROTECTION MEASURES; INCLUDING USE OF EROSION CONTROL FABRIC, SEEDING, AND MULCHING. THE CONTRACTOR SHALL REMOVE ALL MATERIAL STAGED WITHIN THE PROJECT AREA INCLUDING EQUIPMENT, AND EXCESS SUPPLIES. THE PROJECT SITE SHALL BE CLEANED.

## TIDAL DATUM:


TIDAL DATUM IS SHOWN IN NAVD88. CONVERSION FROM NAVD88 TO MLLW, MTL, MHW, MHHW, AND FOR ALA  
SPIT IS:

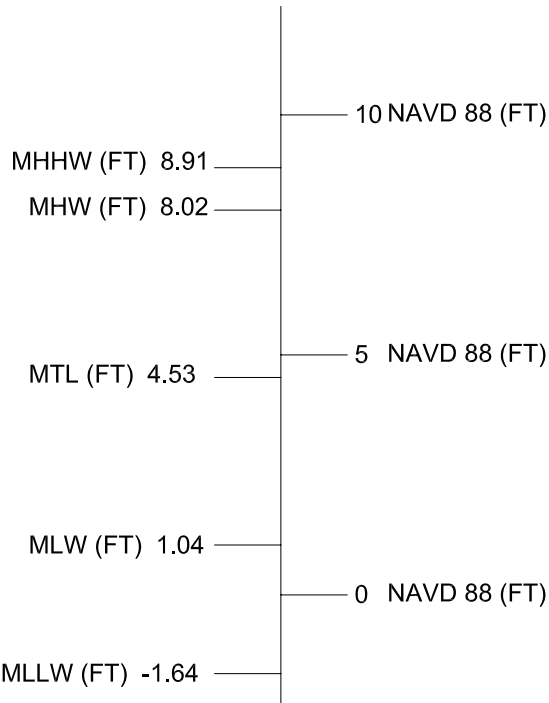

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LEGEND:

	EXISTING CONTOURS
	MHHW
	EXISTING SALT MARSH EXTENTS (APRIL 2008)
	EXISTING DRIFT WOOD EXTENTS (APRIL 2008)
	APPROXIMATE RIPRAP AND CONSTRUCTION DEBRIS EXTENTS

NOTES:

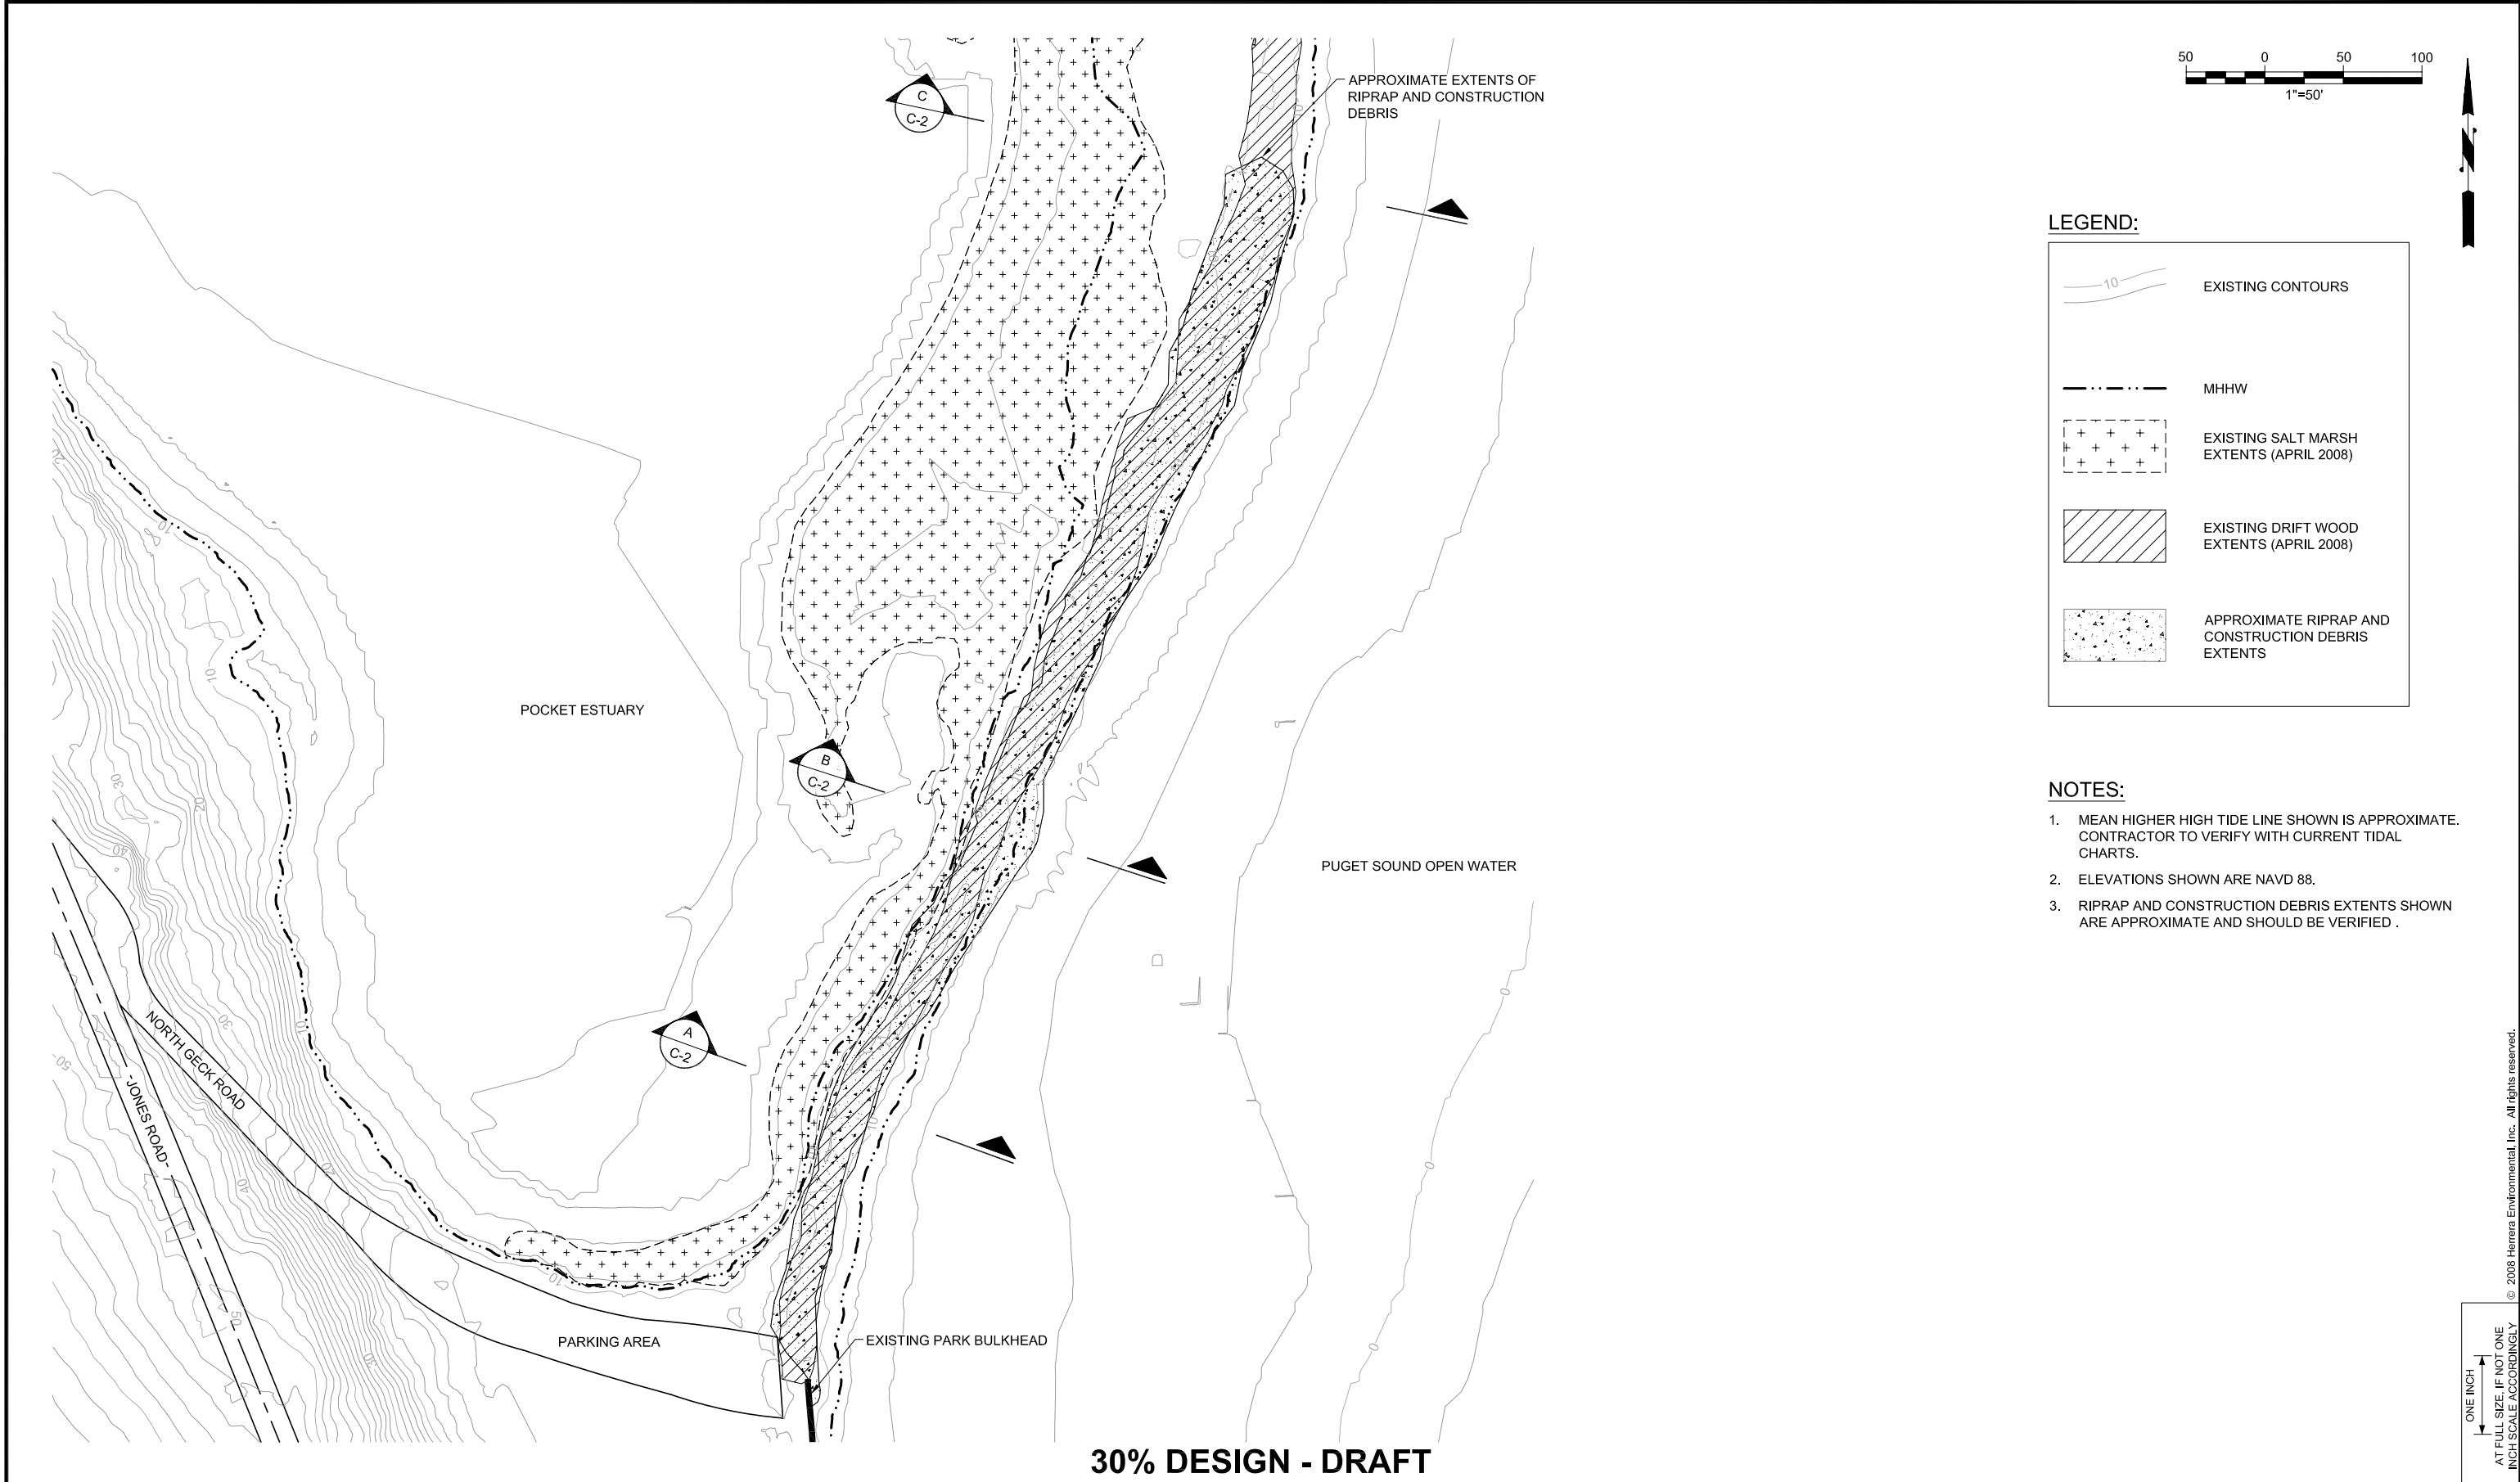1. MEAN HIGHER HIGH TIDE LINE SHOWN IS APPROXIMATE. CONTRACTOR TO VERIFY WITH CURRENT TIDAL CHARTS.
2. ELEVATIONS SHOWN ARE NAVD 88.
3. RIPRAP AND CONSTRUCTION DEBRIS EXTENTS SHOWN ARE APPROXIMATE AND SHOULD BE VERIFIED .

No.	REVISION	BY	APP'D	DATE



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SCALE: AS NOTED	APPROVED: M. SPILLANE

ALA SPIT  
RIPRAP AND CONSTRUCTION DEBRIS REMOVAL  
RESTORATION PROJECT


EXISTING CONDITIONS

DATE:	
JULY 2008	
PROJECT NO:	
06-03192-000	
DRAWING NO:	
C-1	
SHEET NO:	OF
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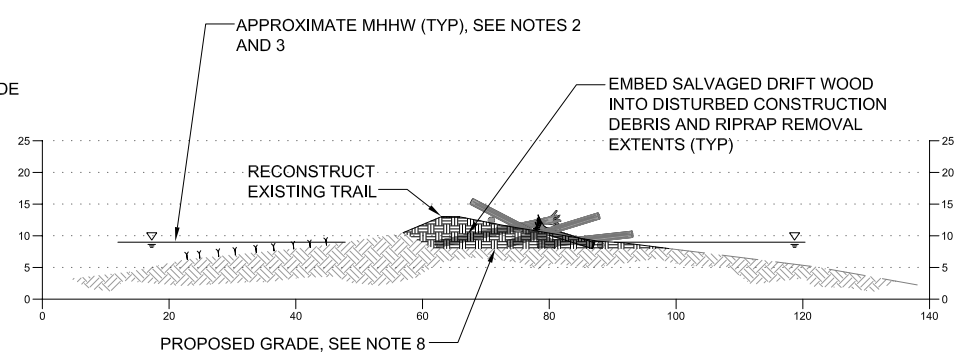
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TYPICAL EXISTING SECTION

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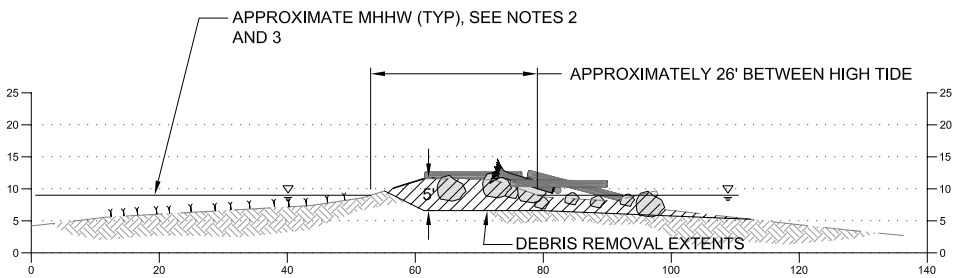
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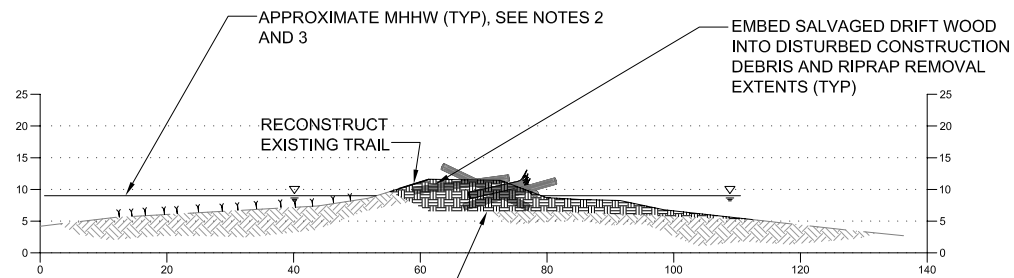
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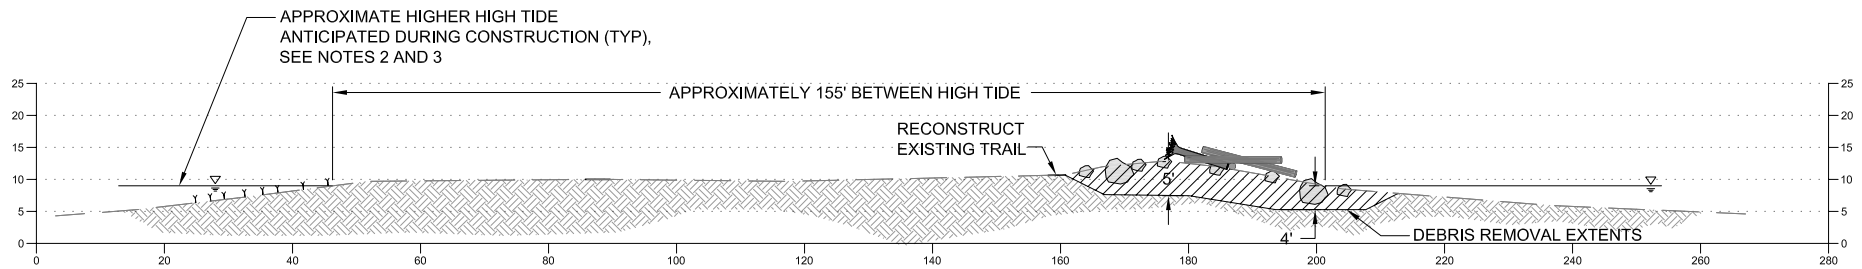
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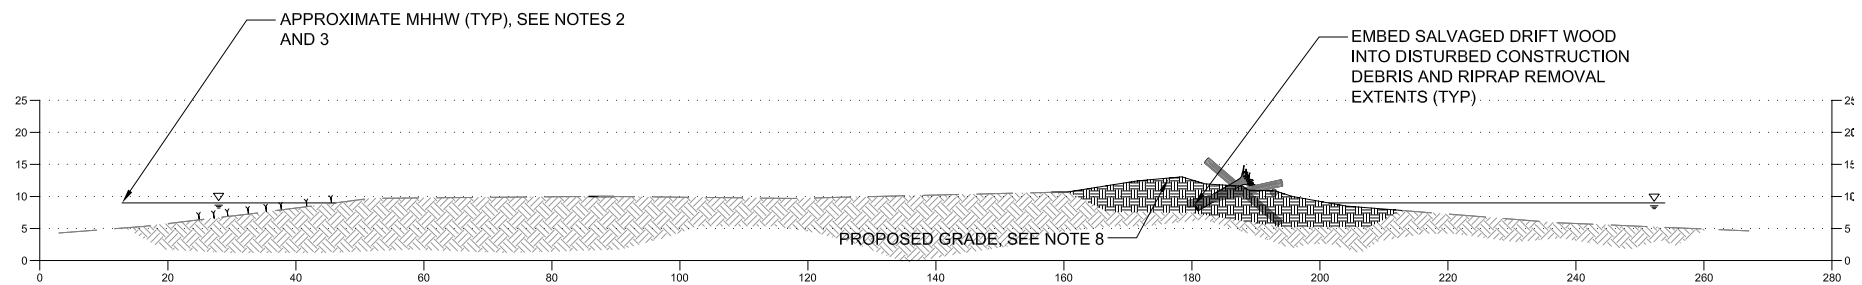
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TYPICAL EXISTING SECTION

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C-1

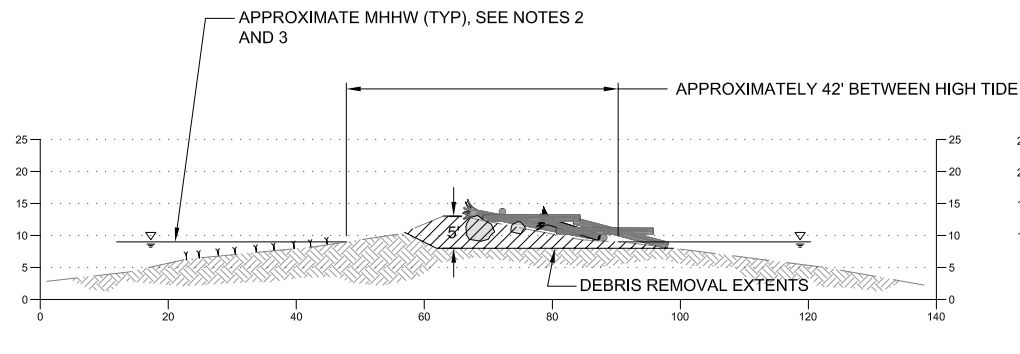


TYPICAL PROPOSED SECTION

SCALE: 1"=15'

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C-3

LEGEND:

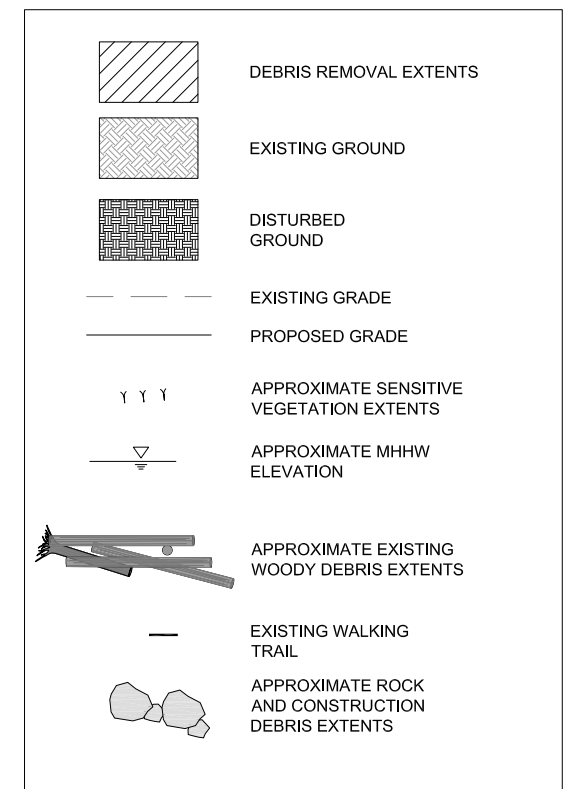

NOTES:

- ELEVATION DATUM SHOWN IS NAVD 88.
- CONTRACTOR SHALL SEQUENCE ACCESS AND EXCAVATIONS WITH TIDES. STATE WATER QUALITY STANDARDS APPLY TO ALL WORK.
- MHHW SHOWN IS APPROXIMATE. CONTRACTOR SHALL PLAN CONTINGENCIES. CONTRACTOR SHALL SEQUENCE CONSTRUCTION DEBRIS EXCAVATION AND REMOVAL BY LEAVING A SOIL PLUG/BERM BETWEEN EXCAVATION AND TIDE WATER TO ISOLATE WORK AREA DURING HIGH TIDES. LOW TIDE ELEVATIONS ARE BELOW ELEVATIONS SHOWN ON DETAILS.
- CONTRACTOR SHALL REMOVE AND STAGE EXISTING WOODY DEBRIS GREATER THAN APPROXIMATELY 10" IN DIAMETER AND A MINIMUM OF 4' IN LENGTH FOR REPLACEMENT FOLLOWING DEBRIS REMOVAL.
- WOODY DEBRIS, VEGETATION, ROCK AND CONSTRUCTION DEBRIS EXTENTS SHOWN ARE APPROXIMATE AND SHALL BE VERIFIED IN THE FIELD.
- EXCAVATIONS THAT ARE ANTICIPATED TO EXTEND INTO OR DISTURB AREAS OF SENSITIVE VEGETATION SHALL HAVE THE TOP 1 FT OF SOIL AND SENSITIVE VEGETATION SALVAGED AND STAGED IN ON-SITE VEGETATION NURSERIES FOR REPLACEMENT FOLLOWING ROCK AND CONSTRUCTION DEBRIS REMOVAL FOR SEED BANK.
- ROCK AND CONSTRUCTION DEBRIS REMOVAL EXTENTS SHOWN ARE APPROXIMATE. CONTRACTOR SHALL REMOVE CONSTRUCTION DEBRIS AND RIPRAP AS SPECIFIED.
- EMBED SALVAGED DRIFT WOOD AS DIRECTED BY ENGINEER.
- FINISH GRADING SHALL BE ADJUSTED BASED ON RIPRAP AND CONSTRUCTION DEBRIS REMOVAL VOLUMES AND EMBEDDED DRIFT WOOD VOLUMES.

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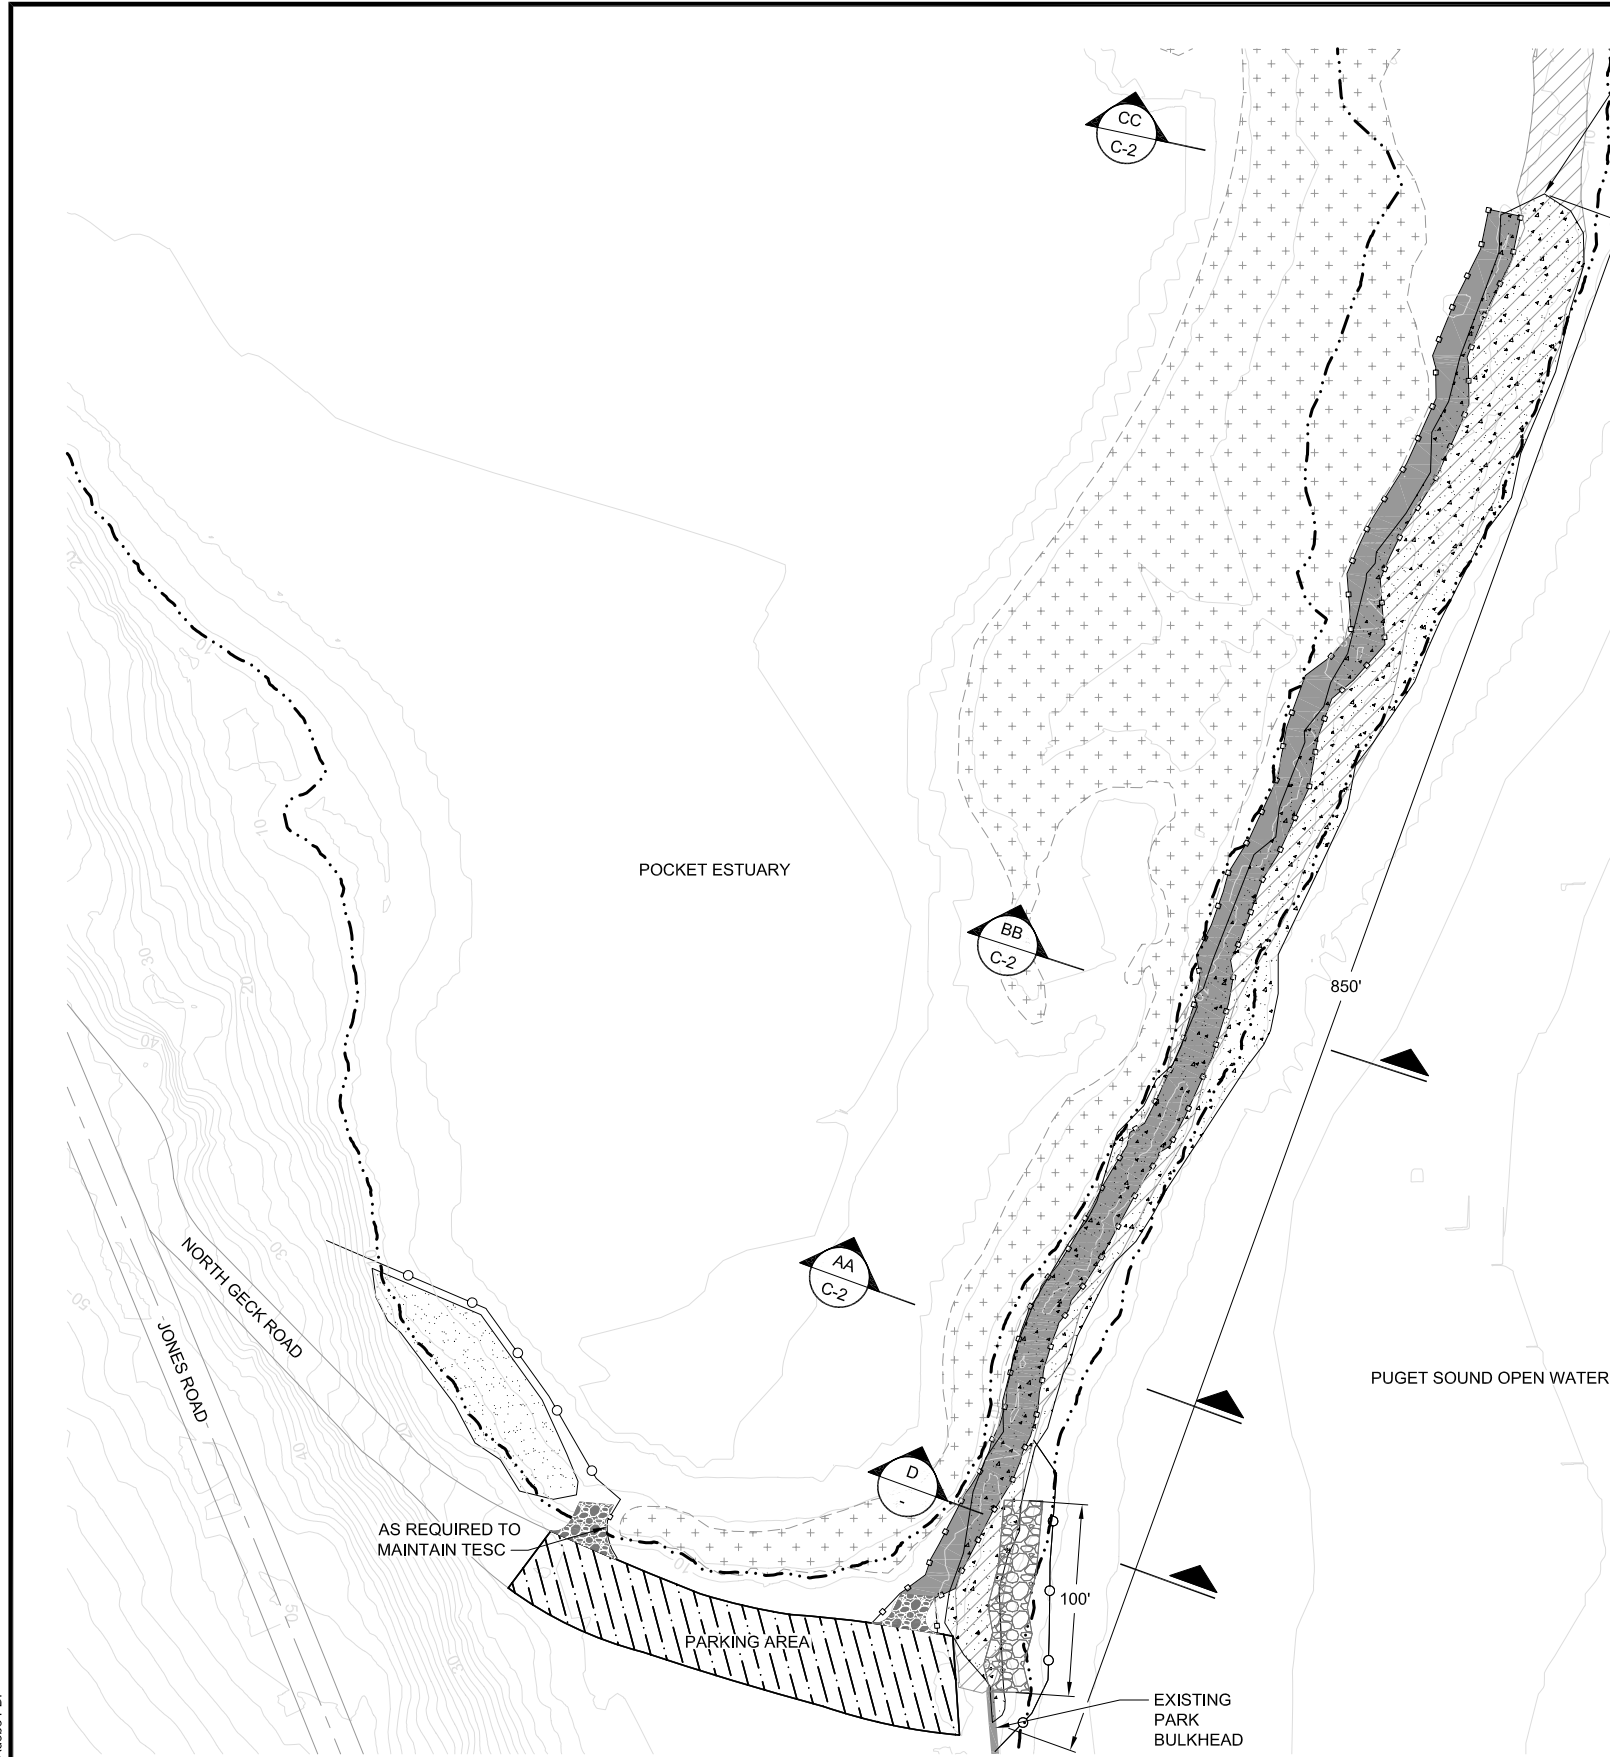
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AS NOTED	M. SPILLANE

ALA SPIT RIPRAP AND CONSTRUCTION DEBRIS REMOVAL RESTORATION PROJECT  EXISTING AND PROPOSED CROSS-SECTIONS	DATE:	JULY 2008
	PROJECT NO:	06-03192-000
	DRAWING NO:	C-2
	SHEET NO:	4 OF 5

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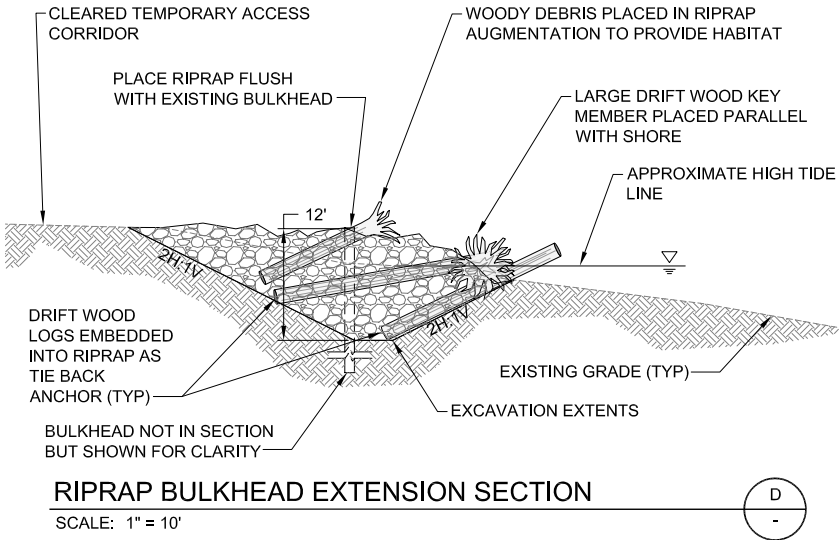


**WORK SEQUENCING NOTES:**


1. CLOSE PARK DURING CONSTRUCTION. INSTALL HIGH VISIBILITY FENCING ACROSS ENTRANCE ROAD (NORTH GECK ROAD) AT STAGING AREA LIMITS.
2. REMOVE PARK BENCH, BEACH ACCESS SIGN, AND TOW SIGN POSTS FOR ACCESS.
3. STAKE DRIFT WOOD TEMPORARY ACCESS CORRIDOR CLEARING LIMITS FOR APPROVAL BY ON SITE ENGINEER.
4. INSTALL TESC MEASURES.
5. INSTALL TEMPORARY STABILIZED CONSTRUCTION ENTRANCE.
6. BEGIN CLEARING AND STAGING OF DRIFTWOOD FOR ACCESS TO SPIT AND FINAL RE-PLACEMENT OF DRIFTWOOD FOLLOWING RIPRAP AND CONSTRUCTION DEBRIS REMOVAL.
7. COORDINATE SALT MARSH VEGETATION REMOVAL AND STOCKPILING FOR SEED BANK AND RE-PLACEMENT FOR RESTORATION OF DISTURBED AREAS.
8. BEGIN RIPRAP AND CONSTRUCTION DEBRIS REMOVAL WORKING FROM OUTER NORTHERN LIMITS OF REMOVAL AREA TOWARDS PARKING LOT. COORDINATE RIPRAP REMOVAL WITH CONSTRUCTION OF RIPRAP AUGMENTATION AREA NORTH OF EXISTING SEA WALL 9.
10. REPLACE DRIFT WOOD AS RIPRAP AND CONSTRUCTION DEBRIS REMOVAL COMMENCES TOWARDS PARKING LOT.
11. DECOMPACT SOIL AND REPLACE SALT MARSH VEGETATION AT ITS ORIGINAL ELEVATION AS RIPRAP AND CONSTRUCTION DEBRIS REMOVAL COMMENCES TOWARDS PARKING LOT.
12. REMOVE REMAINING TESC MEASURES AND MATERIALS AND CONSTRUCTION SITE WORK LIMITS FENCING.

**NOTES:**

1. STAGING AREA TO BE RESTRICTED TO EXISTING PARKING LOT.
2. ACCESS CORRIDOR TO BE STAKED BY CONTRACTOR AND APPROVED BY ENGINEER PRIOR TO CLEARING OR GRUBBING.
3. REMOVE ALL IMPORTED ROCK AND MATERIALS USED FOR TEMPORARY STABILIZED CONSTRUCTION ENTRANCES AND TEMPORARY ACCESS CORRIDORS FOLLOWING CONSTRUCTION.
4. ELEVATIONS SHOWN ARE NAVD 88.
5. TEMPORARY NURSERY SHOULD BE AT THE SAME ELEVATION AS THE AREA OF VEGETATION ORIGIN.



**LEGEND:**

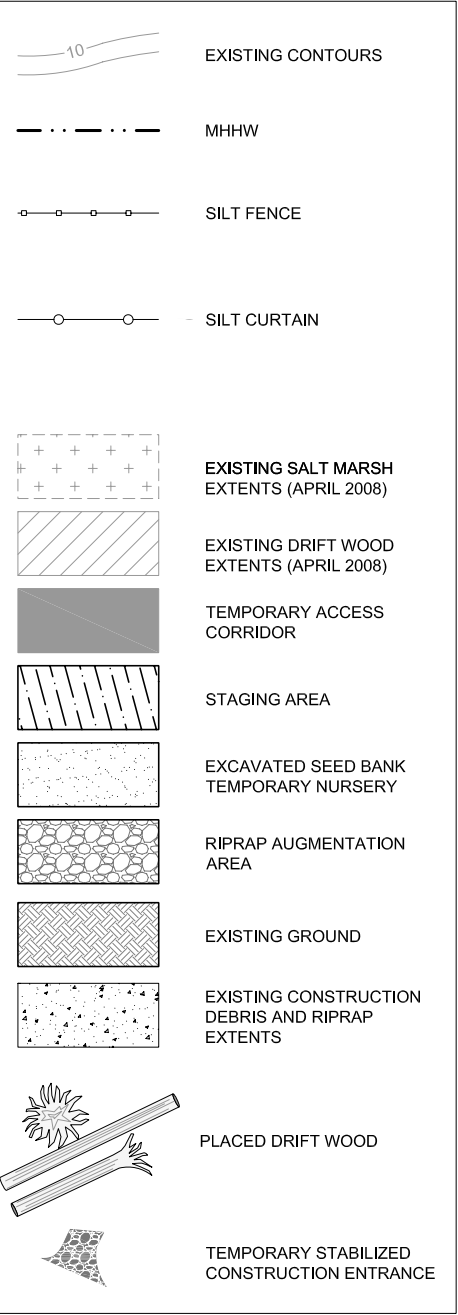

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SCALE: AS NOTED	APPROVED: M. SPILLANE

<b>ALA SPIT RIPRAP AND CONSTRUCTION DEBRIS REMOVAL RESTORATION PROJECT</b>  <b>WORK SEQUENCING</b>	DATE: JULY 2008
	PROJECT NO: 06-03192-000
	DRAWING NO: <b>C-3</b>
	SHEET NO: 5 OF 5