## **60% DESIGN SUBMITTAL**

# MEADOWDALE BEACH PARK AND ESTUARY DESIGN

2000

SCALE IN FEET

### SNOHOMISH COUNTY PARKS AND RECREATION



SOURCE: ESRI

VICINITY MAP


COUNTY EXECUTIVE: COUNCIL:

SITE ADDRESS: 6026 156TH STREET SOUTHEAST, EDMONDS, WASHINGTON 98036

PROJECT CESCI:

SECTION/TOWNSHIP/RANGE

- ALL EMPLOYEES MUST COMPLY WITH BNSF SAFETY REQUIREMENTS. THIS INCLUDES BUT IS NOT LIMITED TO, PASSING A SAFETY COURSE, OBTAINING DOCUMENTATION OF SUCCESSFULLY PASSING THE COURSE, AND ADHERING TO REQUIREMENTS IDENTIFIED IN THE COURSE. THE REQUIRED BNSF SAFETY COURSE MAY BE ACCESSED AT THE FOLLOWING WEBSITE: WWW.RAILROADCOURSES.COM.
- A BNSF FLAGGER SHALL BE PRESENT ANY TIME THE CONTRACTOR IS WORKING WITHIN 25 FEET OF THE TRACKS. THE CONTRACTOR SHALL COMMUNICATE WITH THE OWNER TO ARRANGE FOR A FLAGGER TO BE PRESENT DURING THESE TIMES.

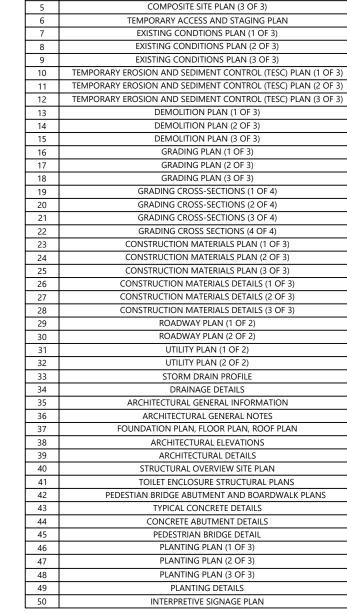

SHEET

2

4

DRAWING INDEX DRAWING

COVER SHEET

SHEET LAYOUT KEY PLAN

COMPOSITE SITE PLAN (1 OF 3)

COMPOSITE SITE PLAN (2 OF 3)

### Prime Consultant



Suite 1900 Seattle WA. 98101 (206) 287-9130

DESCRIPTION

G-1

G-2

G-3

G-4

G-5

G-6

EC-2

FC-3

T-1

T-2

T-3

D-1

D-2

D-3

C-1

C-2

C-3

C-4

C-5

C-6

C-7

CM-1

CM-2

CM-3

CM-4

CM-5

CM-6

RD-1

RD-2

CU-1

CU-2

CU-3

CU-4

A-1.0

A-1.1

A-2.0

A-3.0

A-7.0

S-2.1

S-2.2

S-2.3

S-3.1

S-3.3

S-4

L-1

L-2

L-3

1-4

IS-1

#### **Architectural Consultant**

Salt Studio LLC 66 Bell Street Unit #1 Seattle, WA 98121 (206) 948-2104

#### Surveyor

Duane Hartman and Associates 16928 Woodinville-Redmond Road, Suite B-107 Woodinville, WA 98072 (425) 483-5355

### Structural Engineering Consultant

Swenson Say Faget 2124 Third Ave, Suite 100 Seattle, WA 98121 (206) 443-6212

#### Mechanical Engineering Consultant

Rainbow Consulting 336 NW 50th St Seattle, WA 98107 (206) 235-6002

#### Irrigation Consultant

William Stewart Design 9220 58th Avenue SE Olympia, WA 98513 (206) 605-9863

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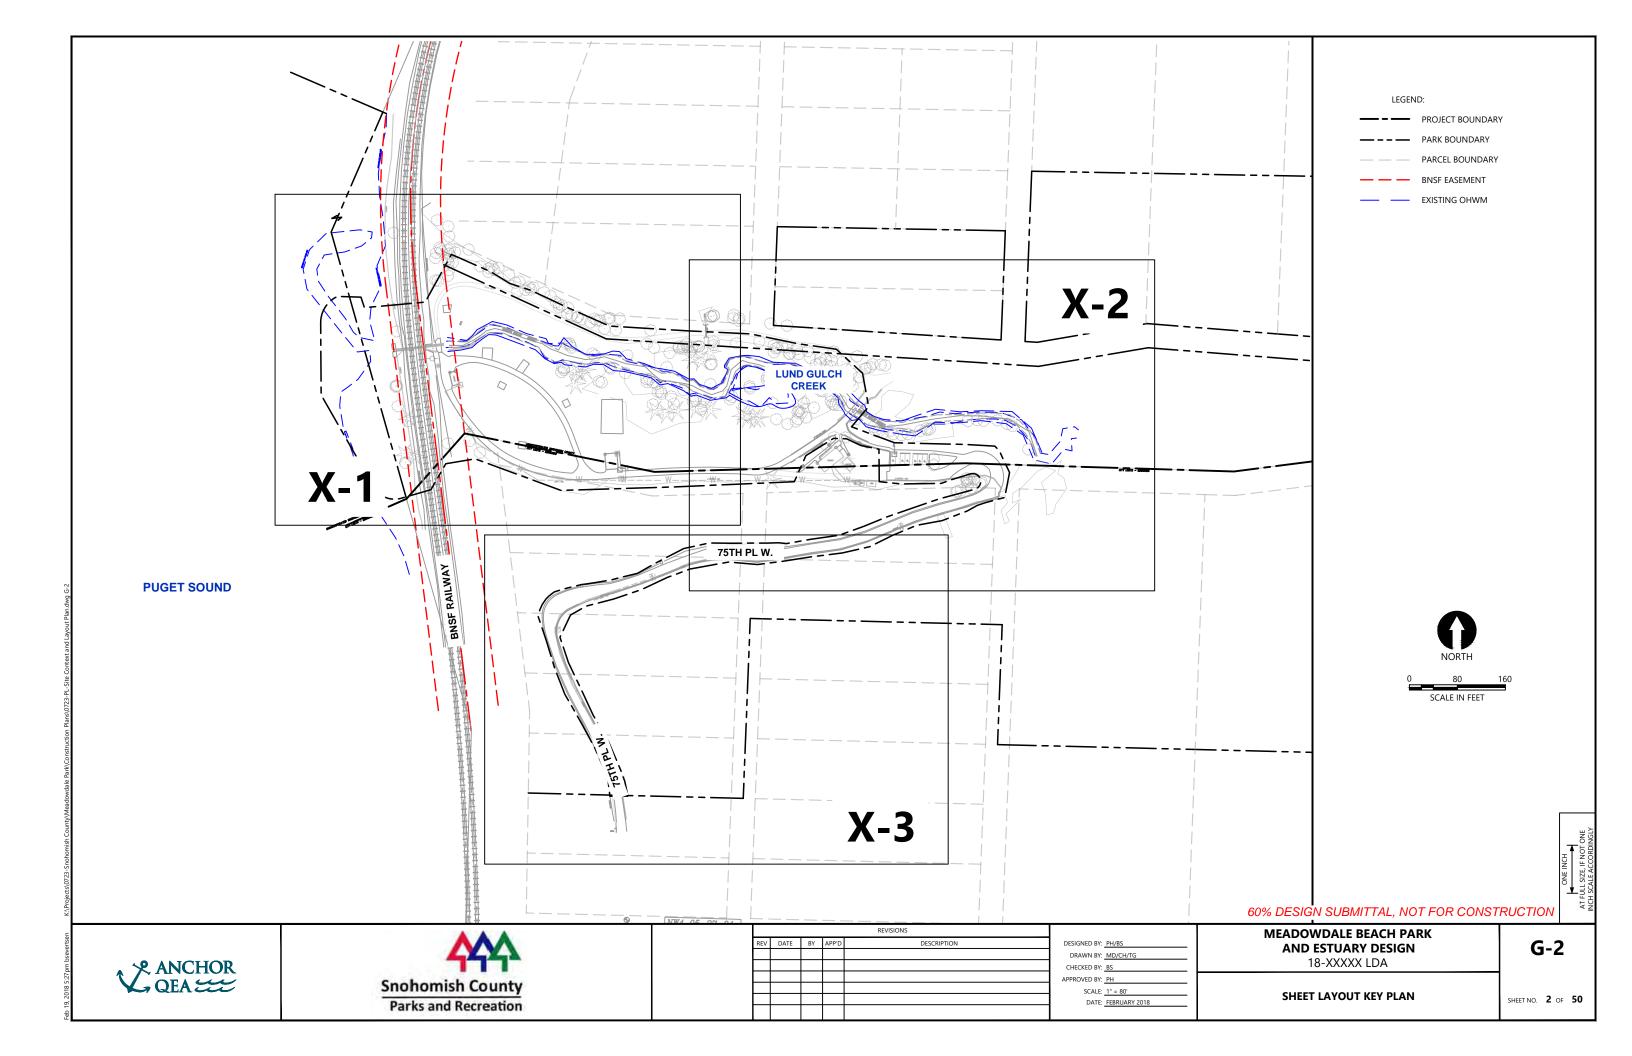
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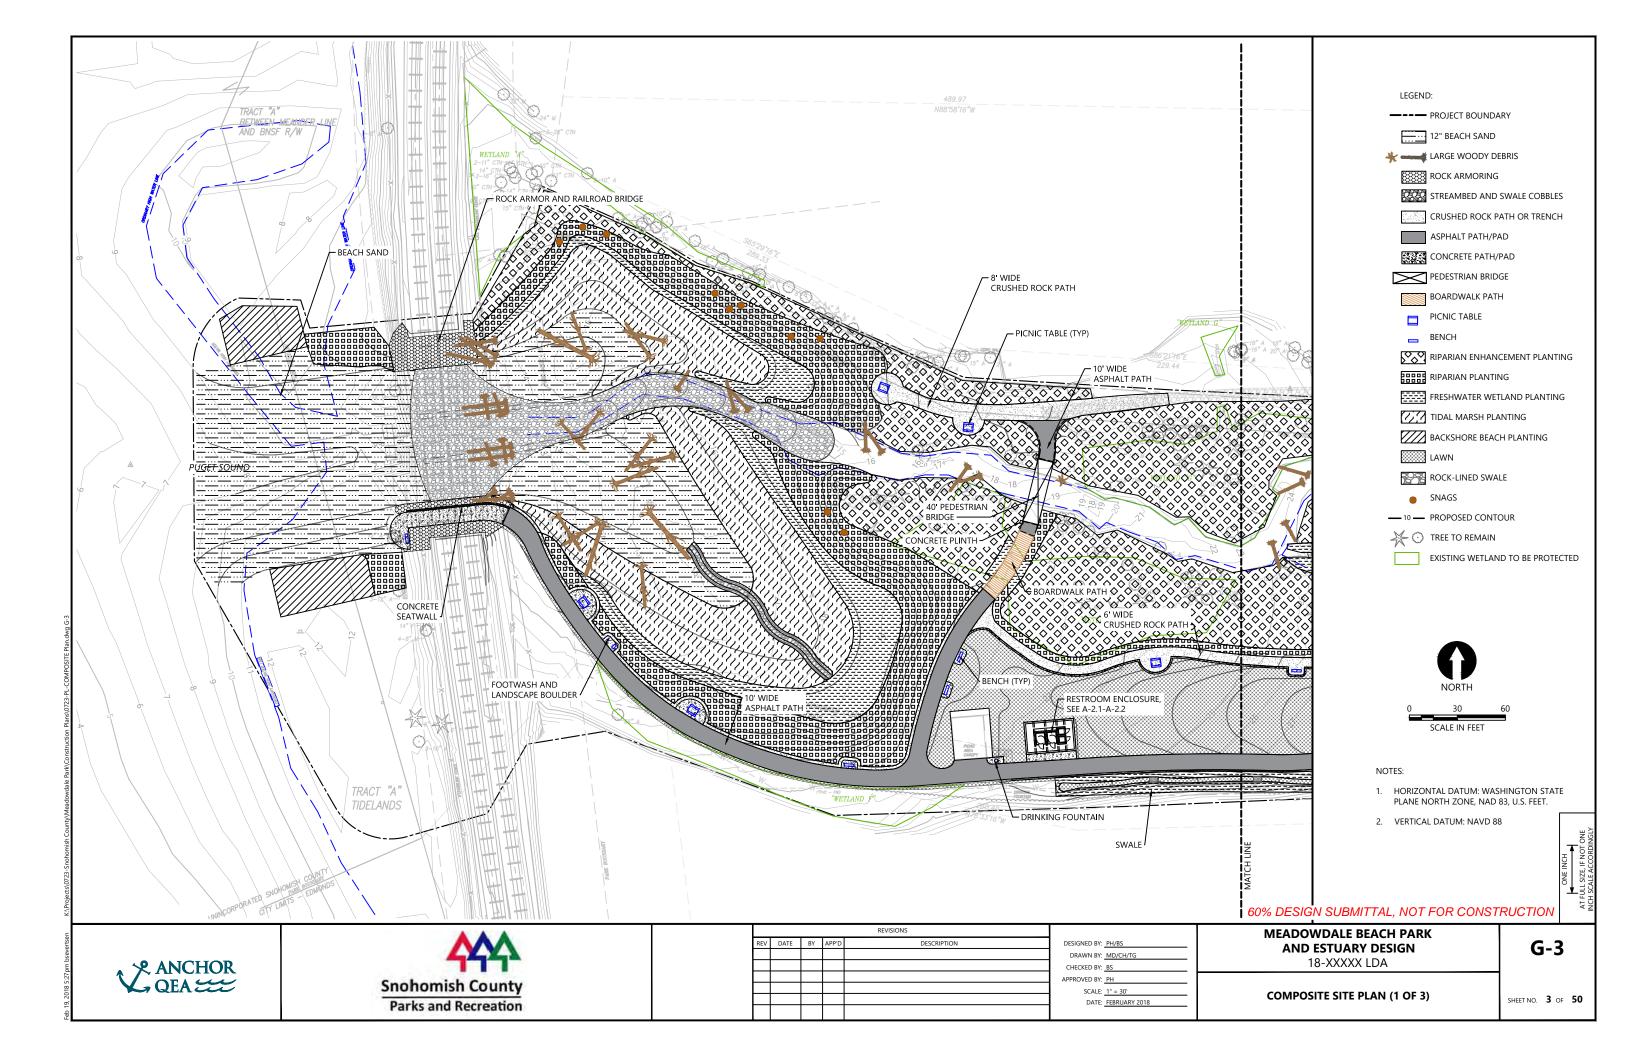
**MEADOWDALE BEACH PARK AND ESTUARY DESIGN** 18-XXXXX LDA


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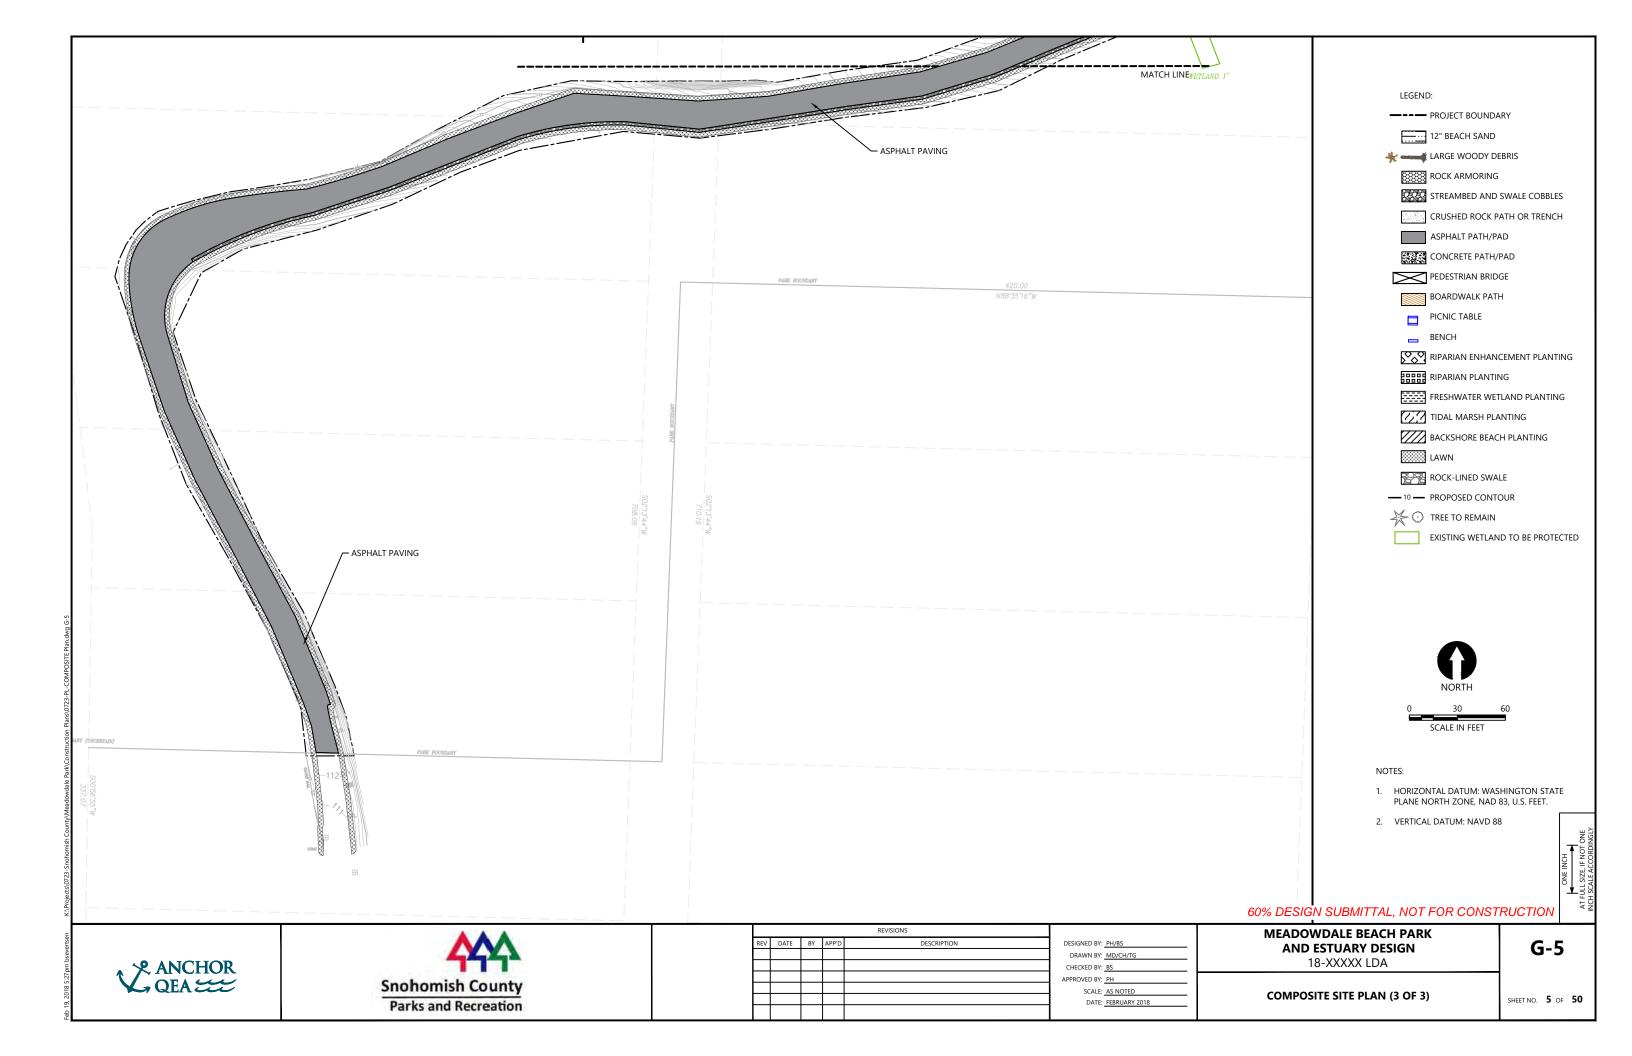
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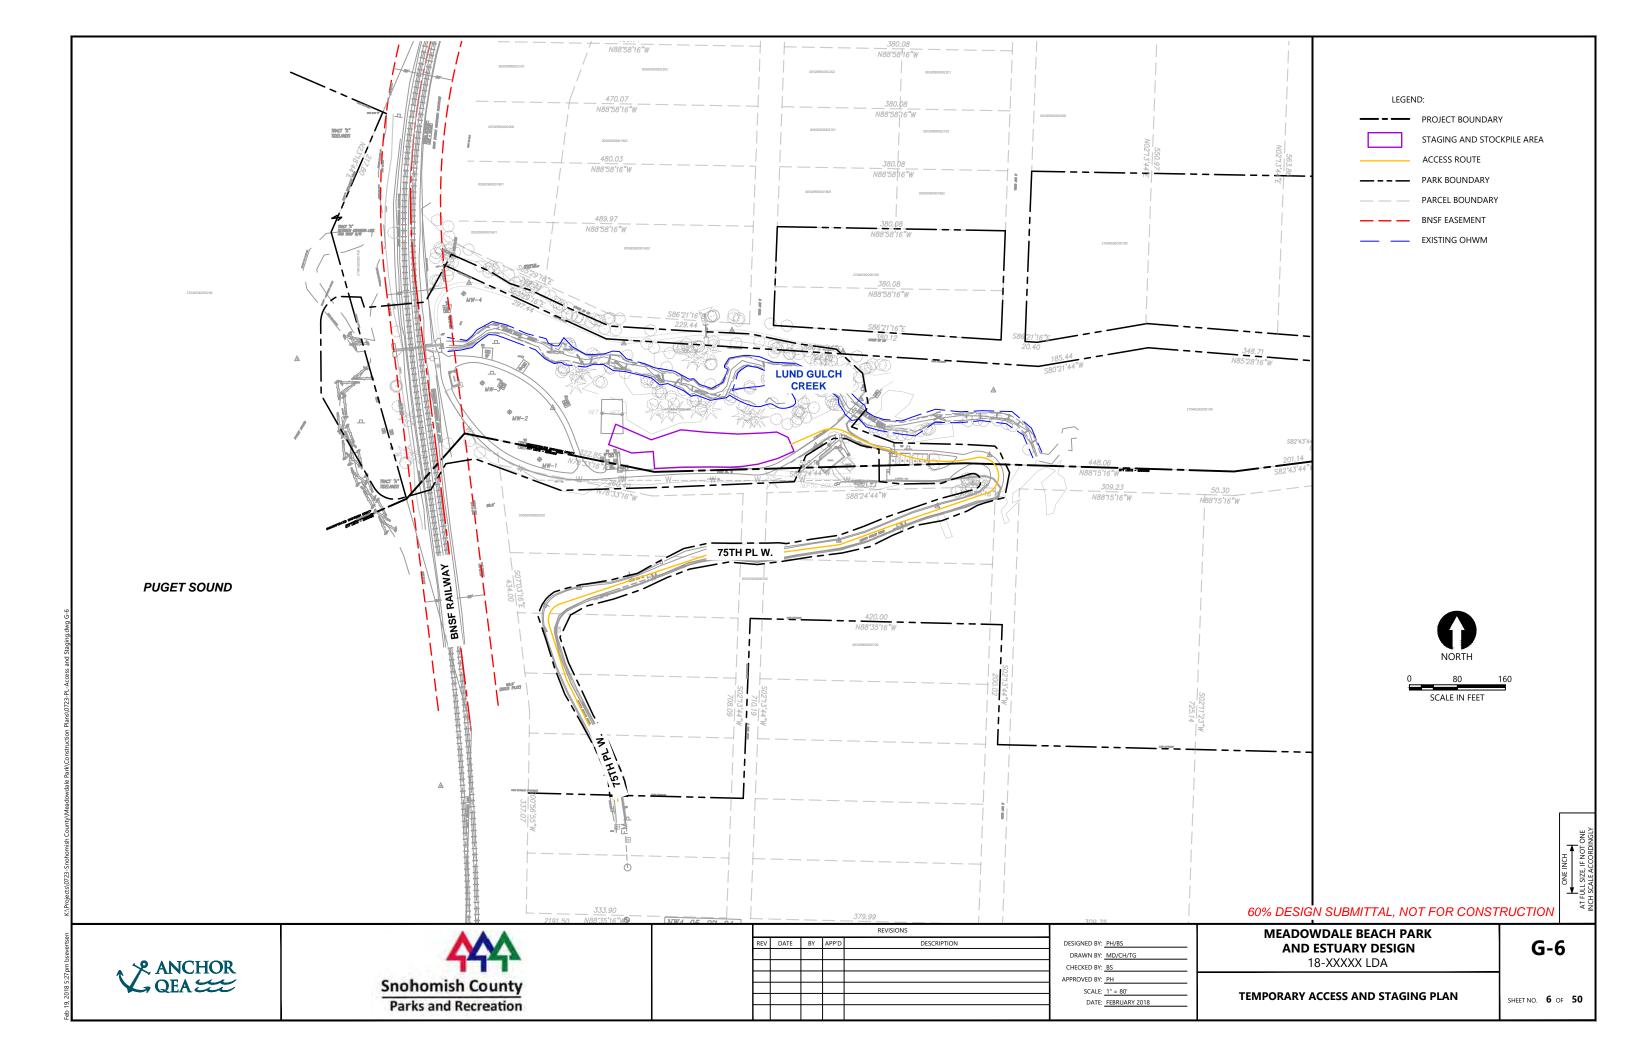
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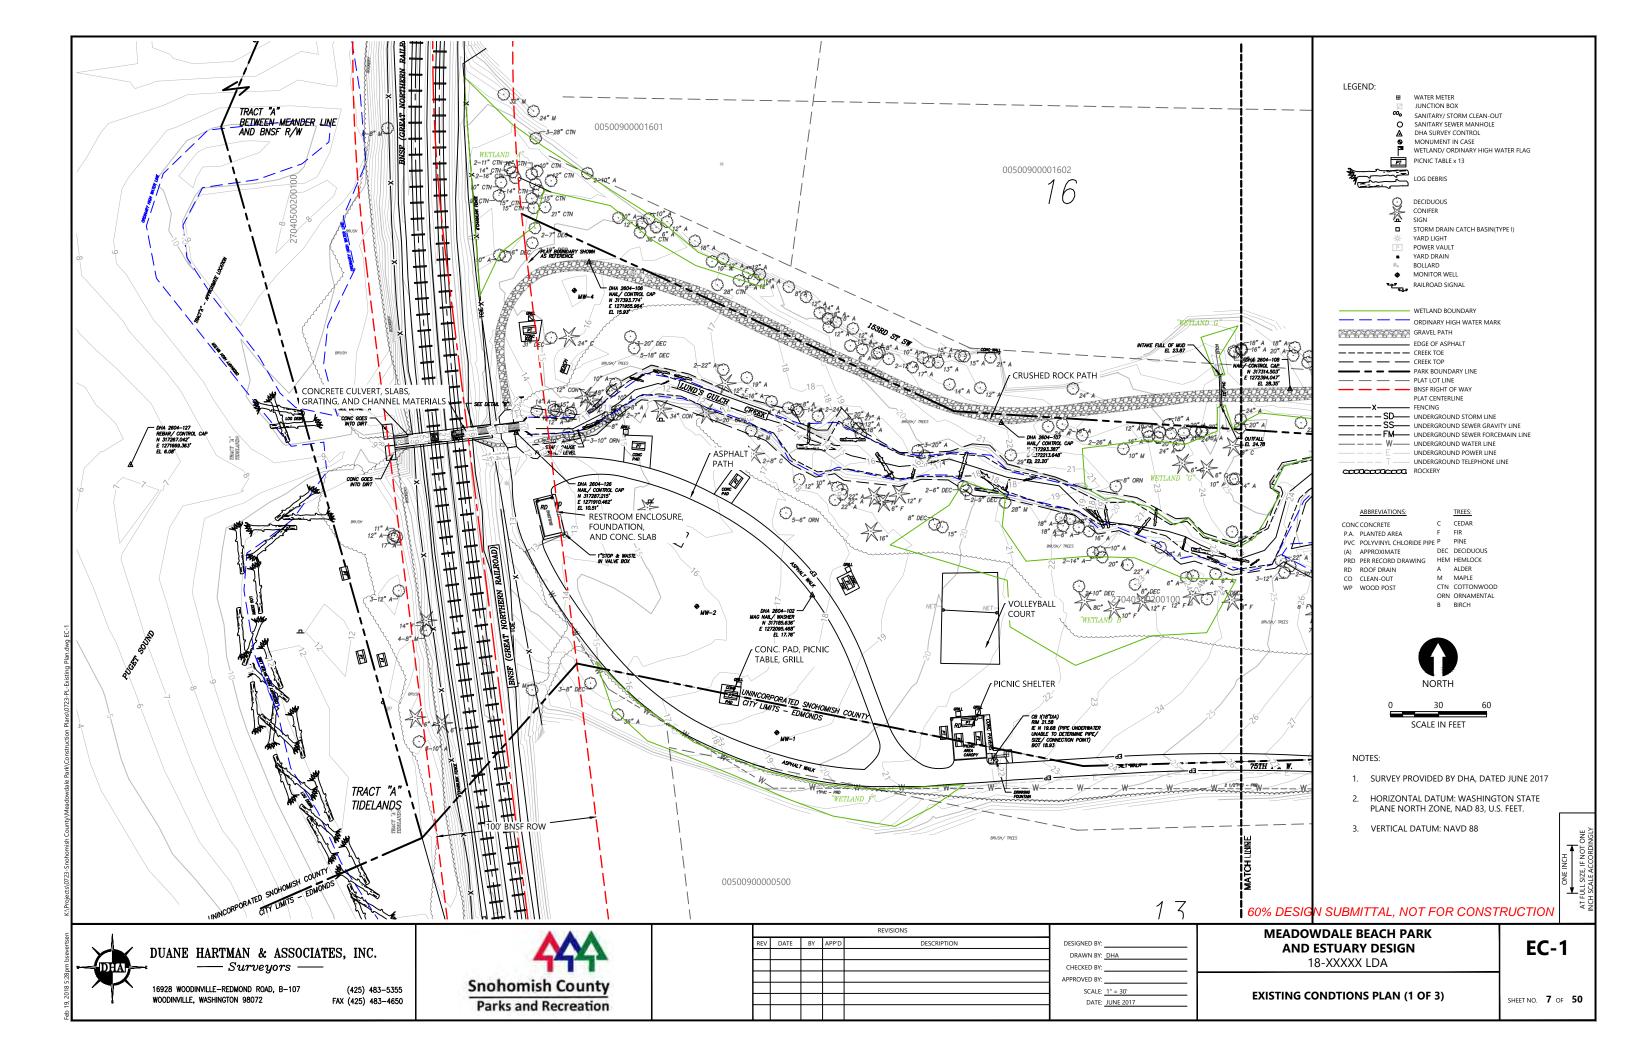














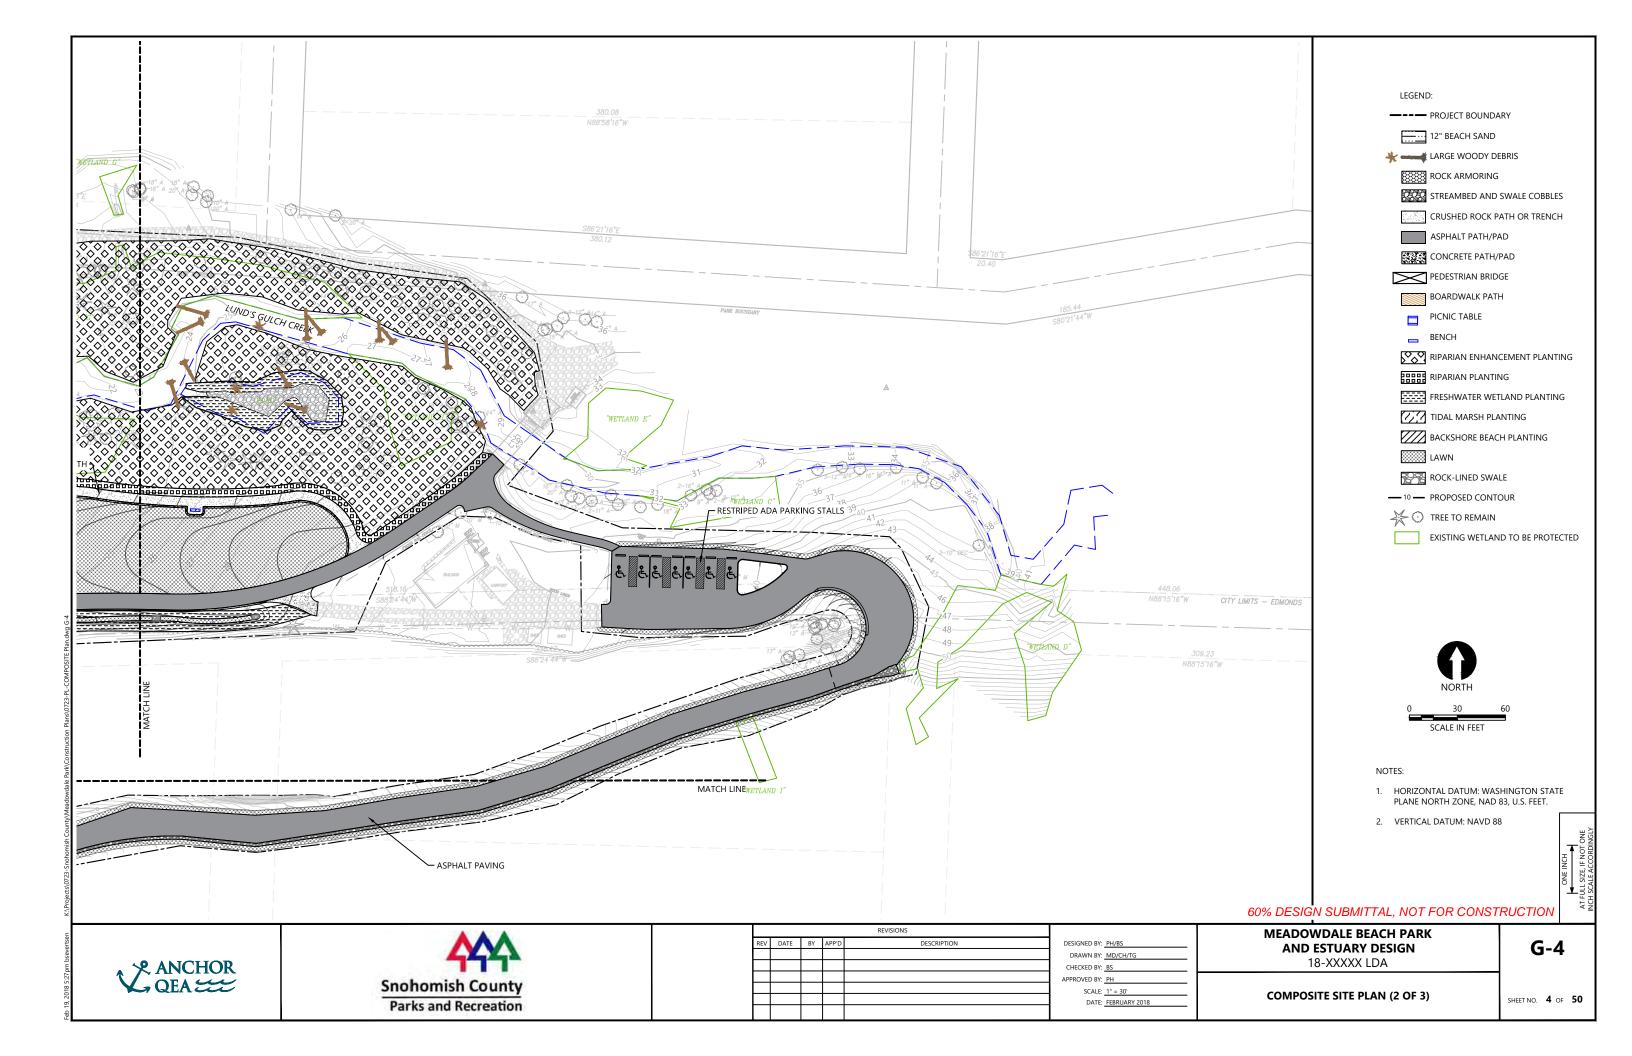


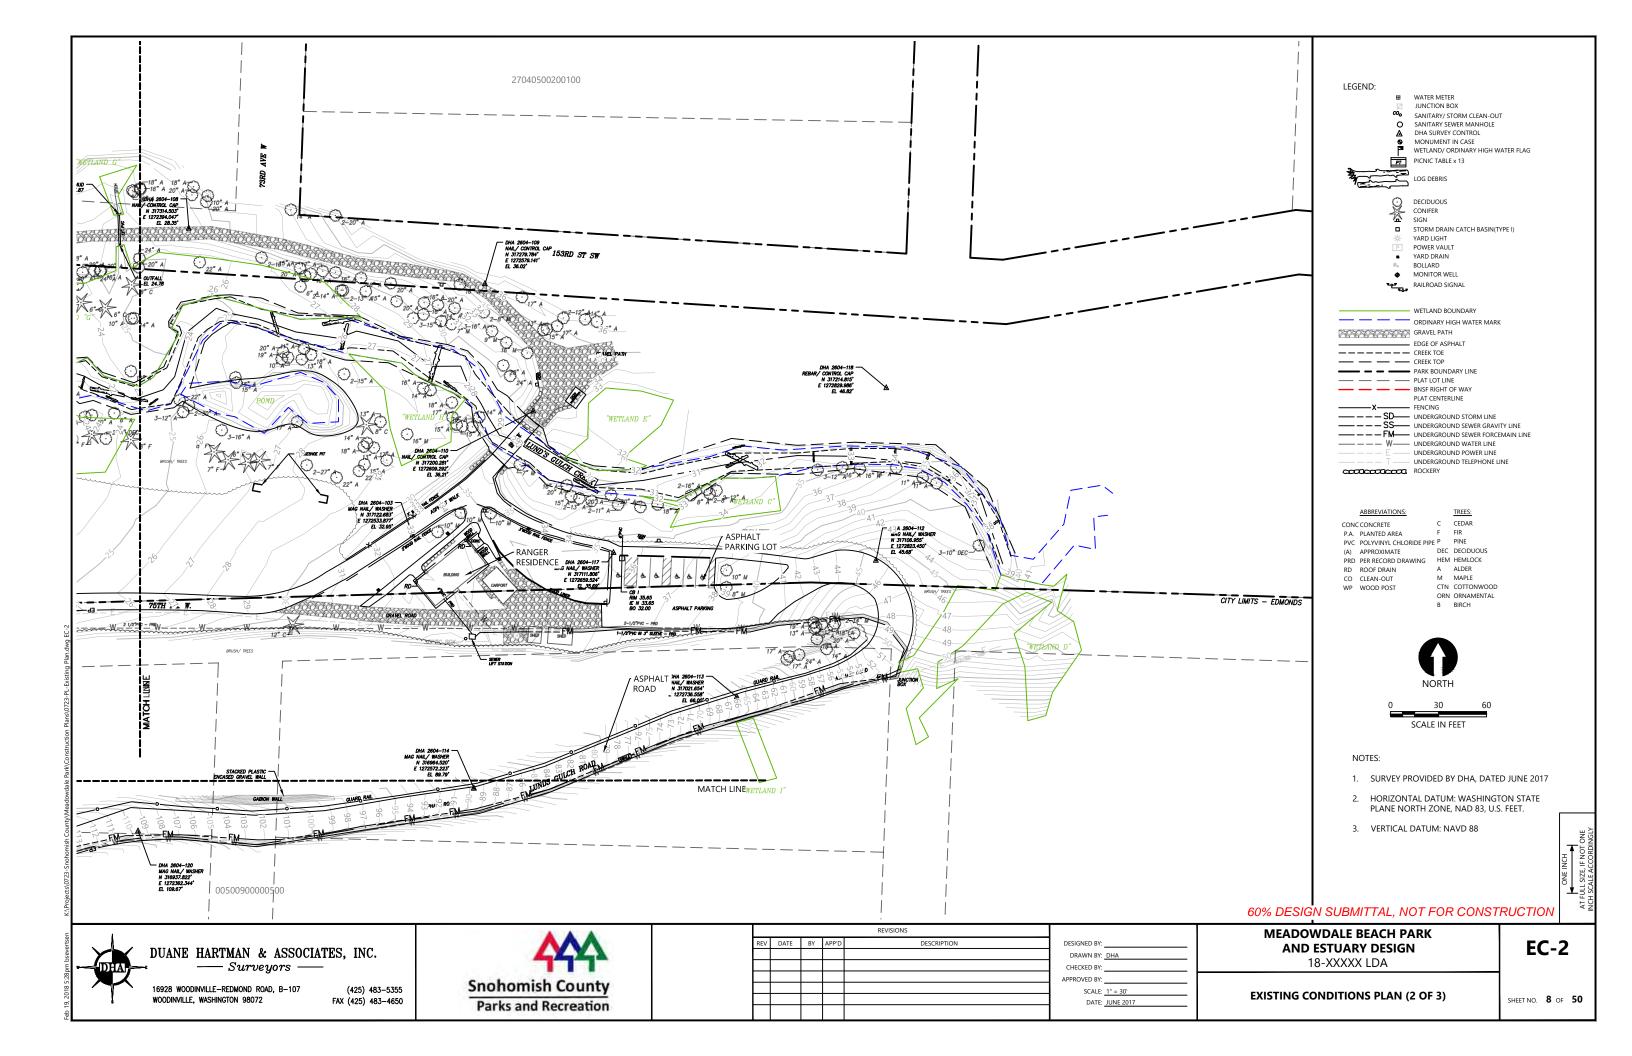


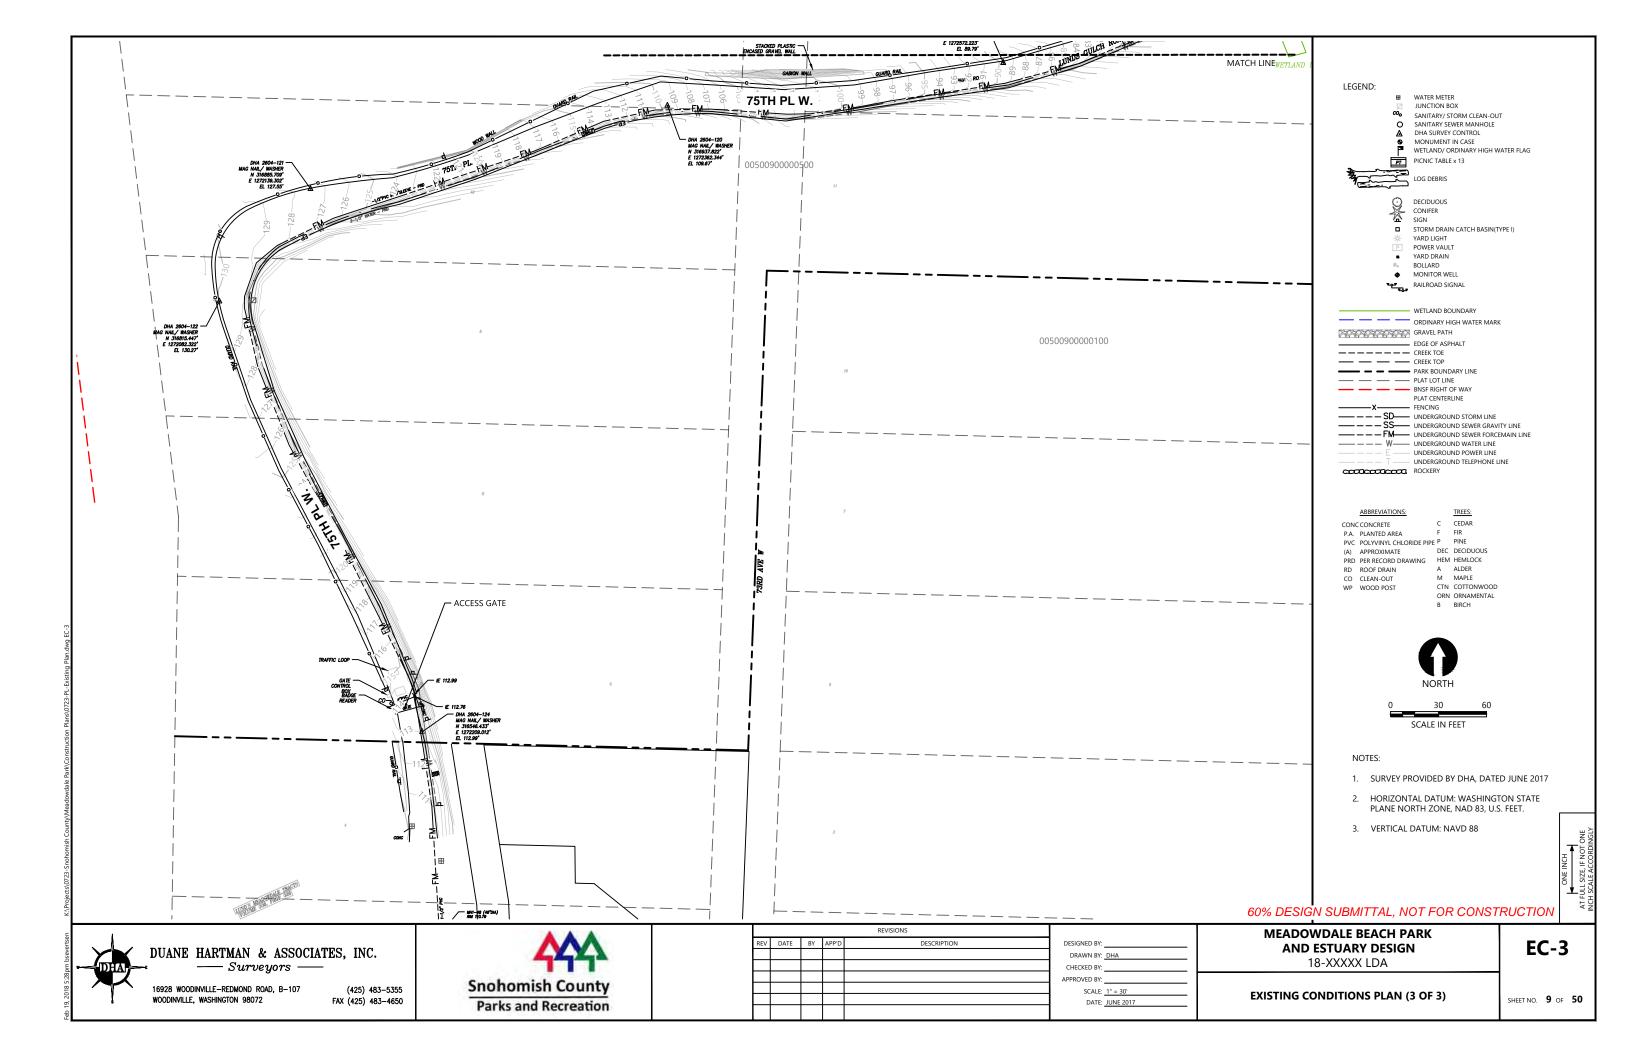


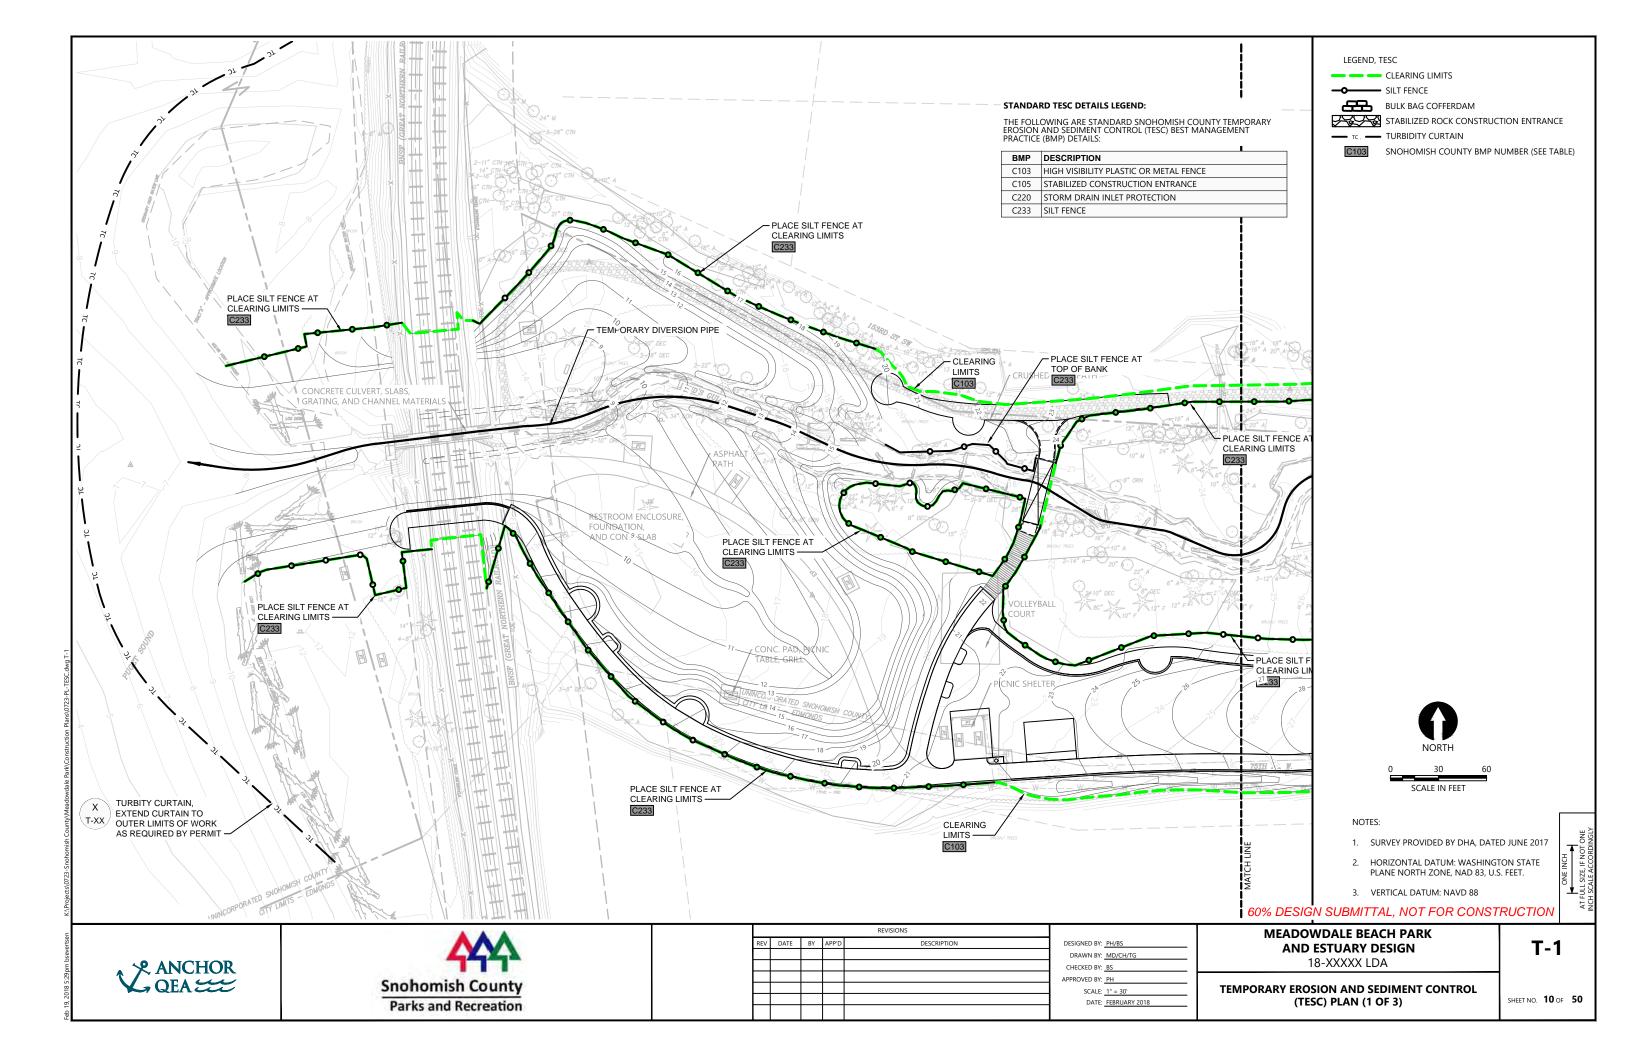


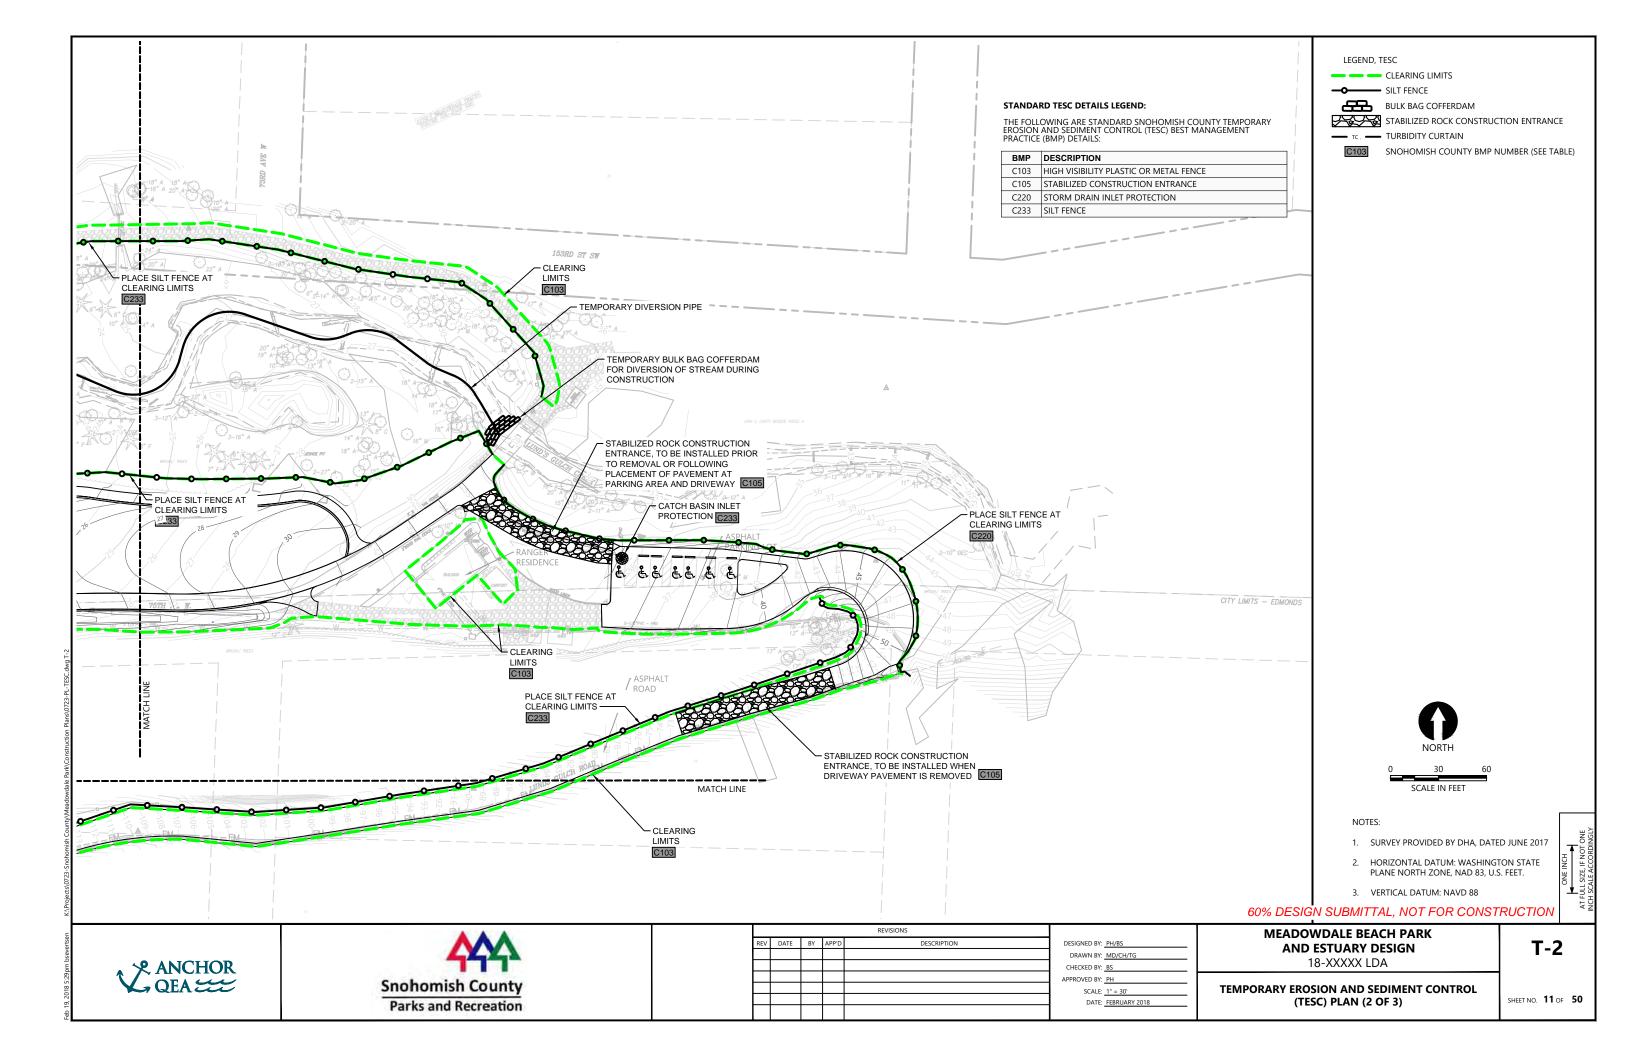


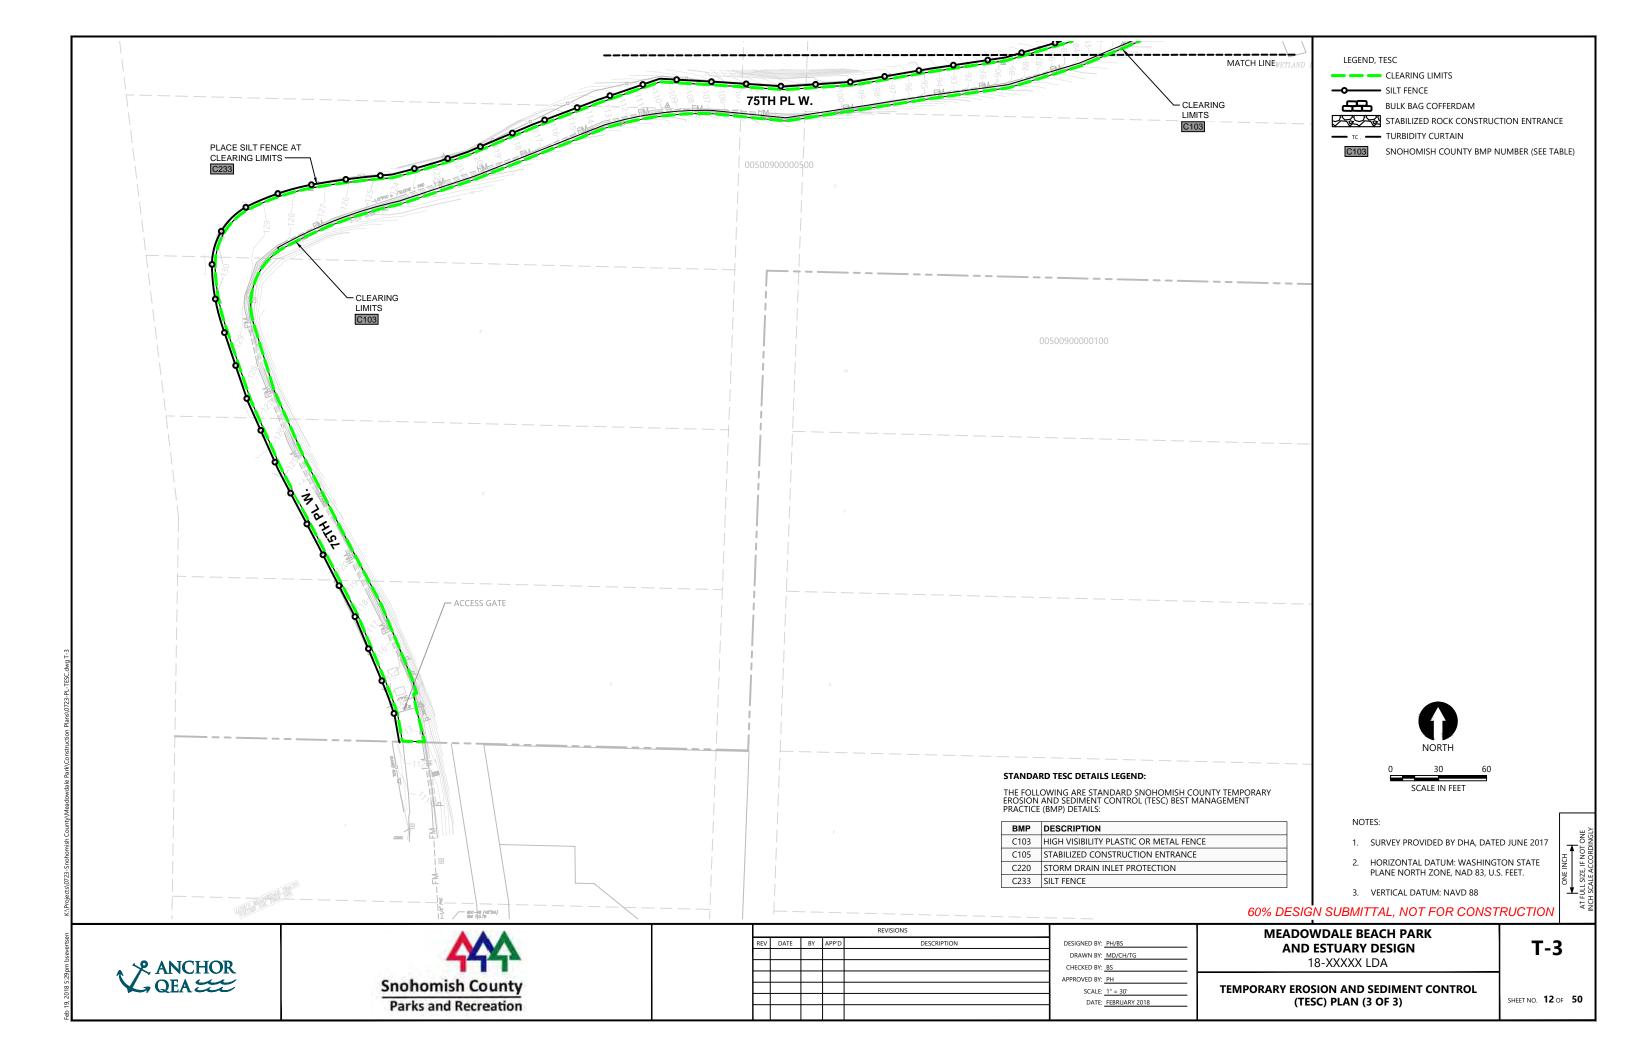


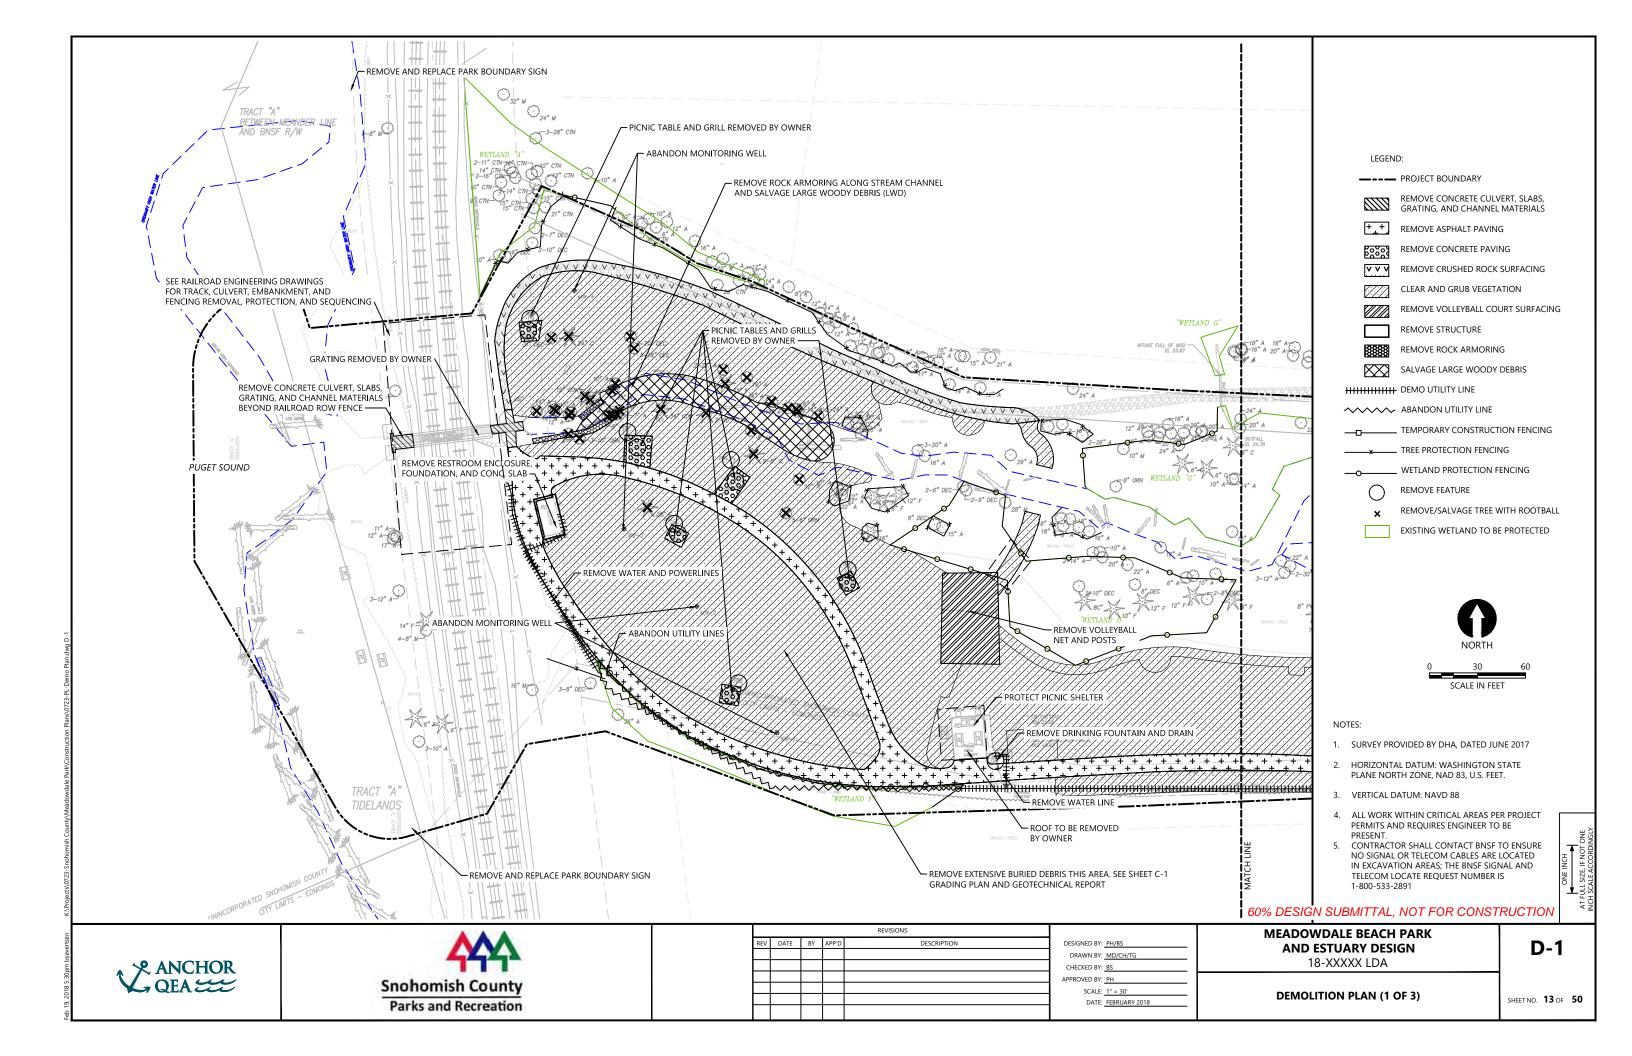


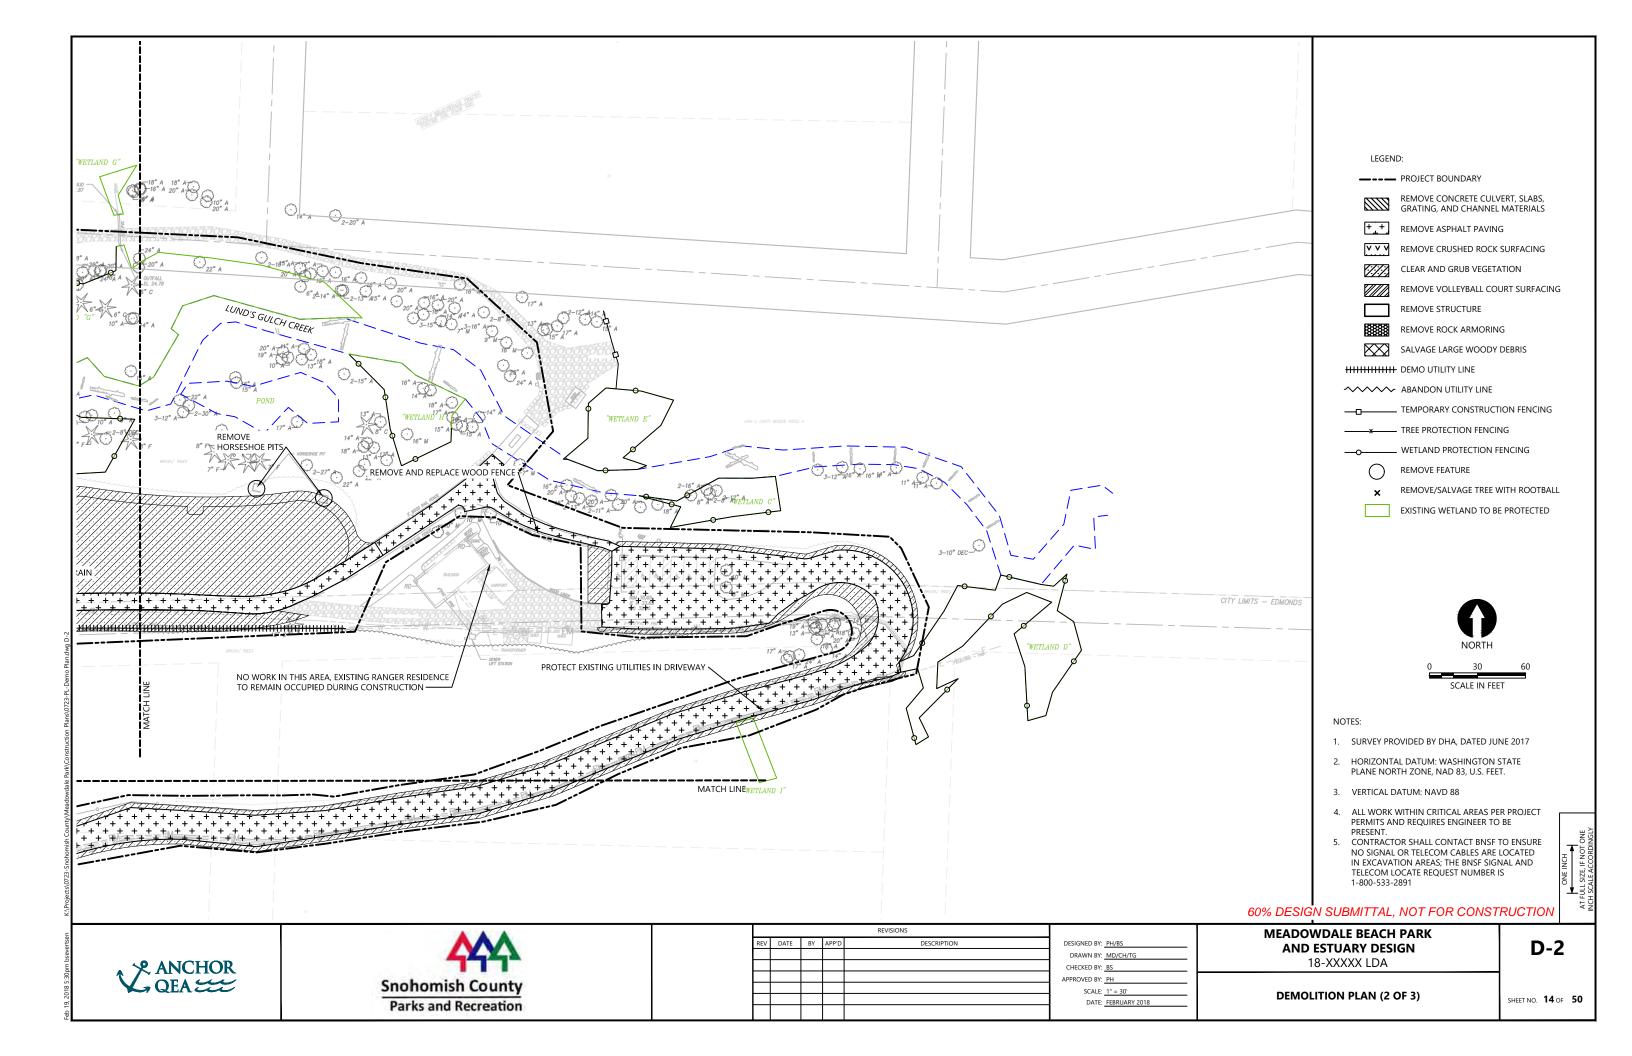


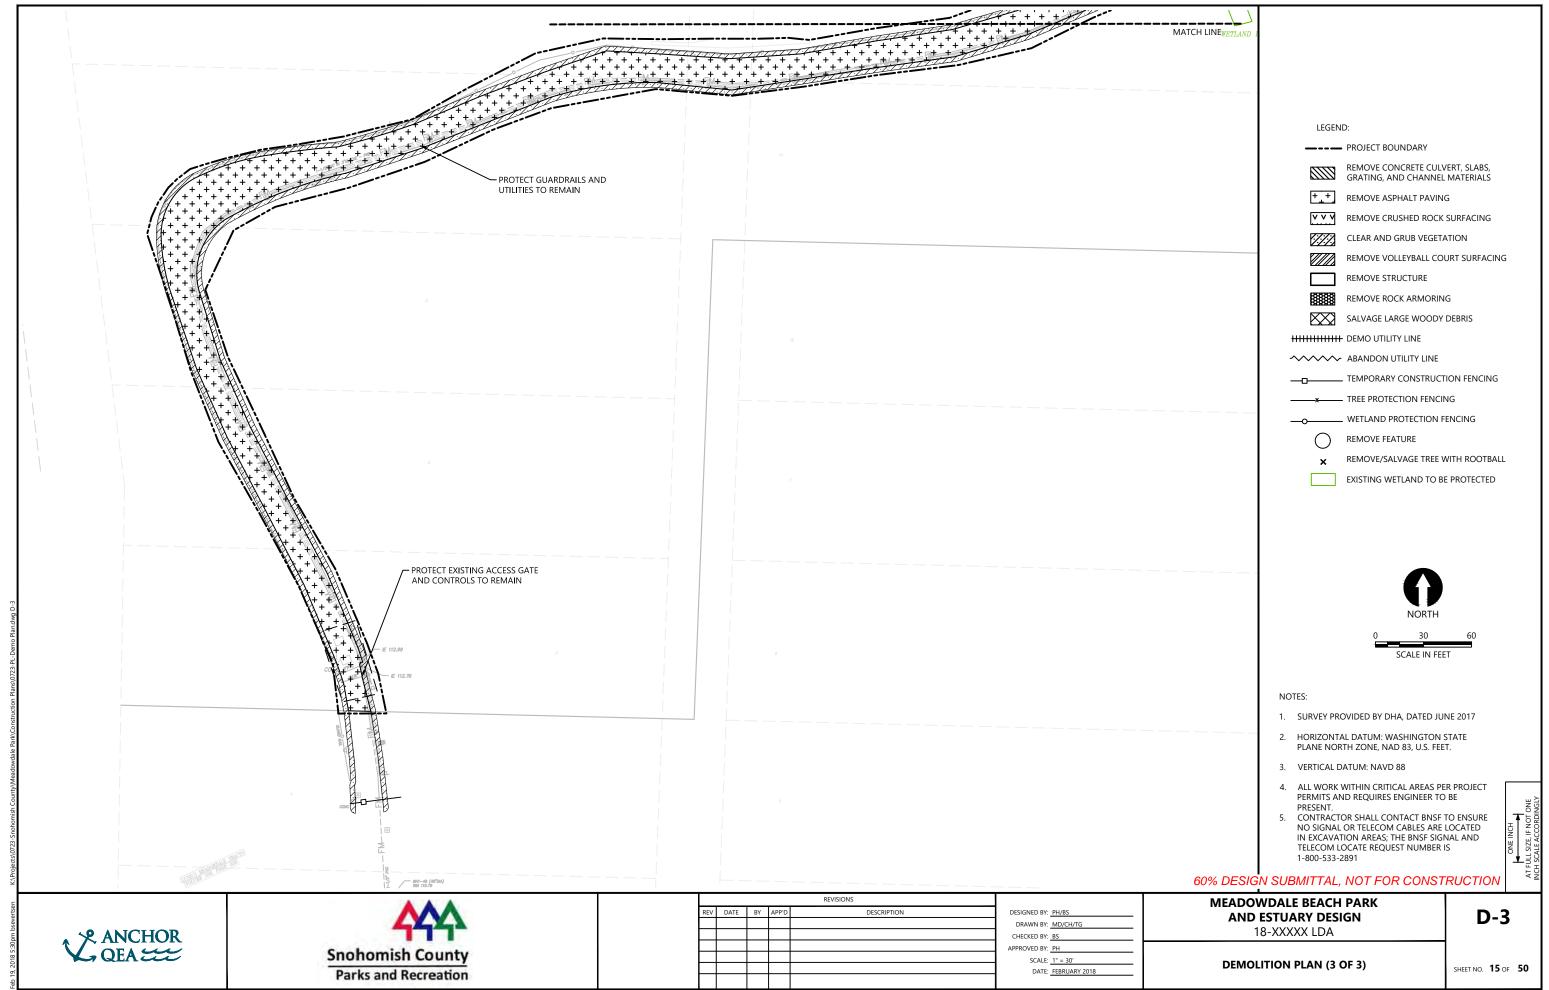


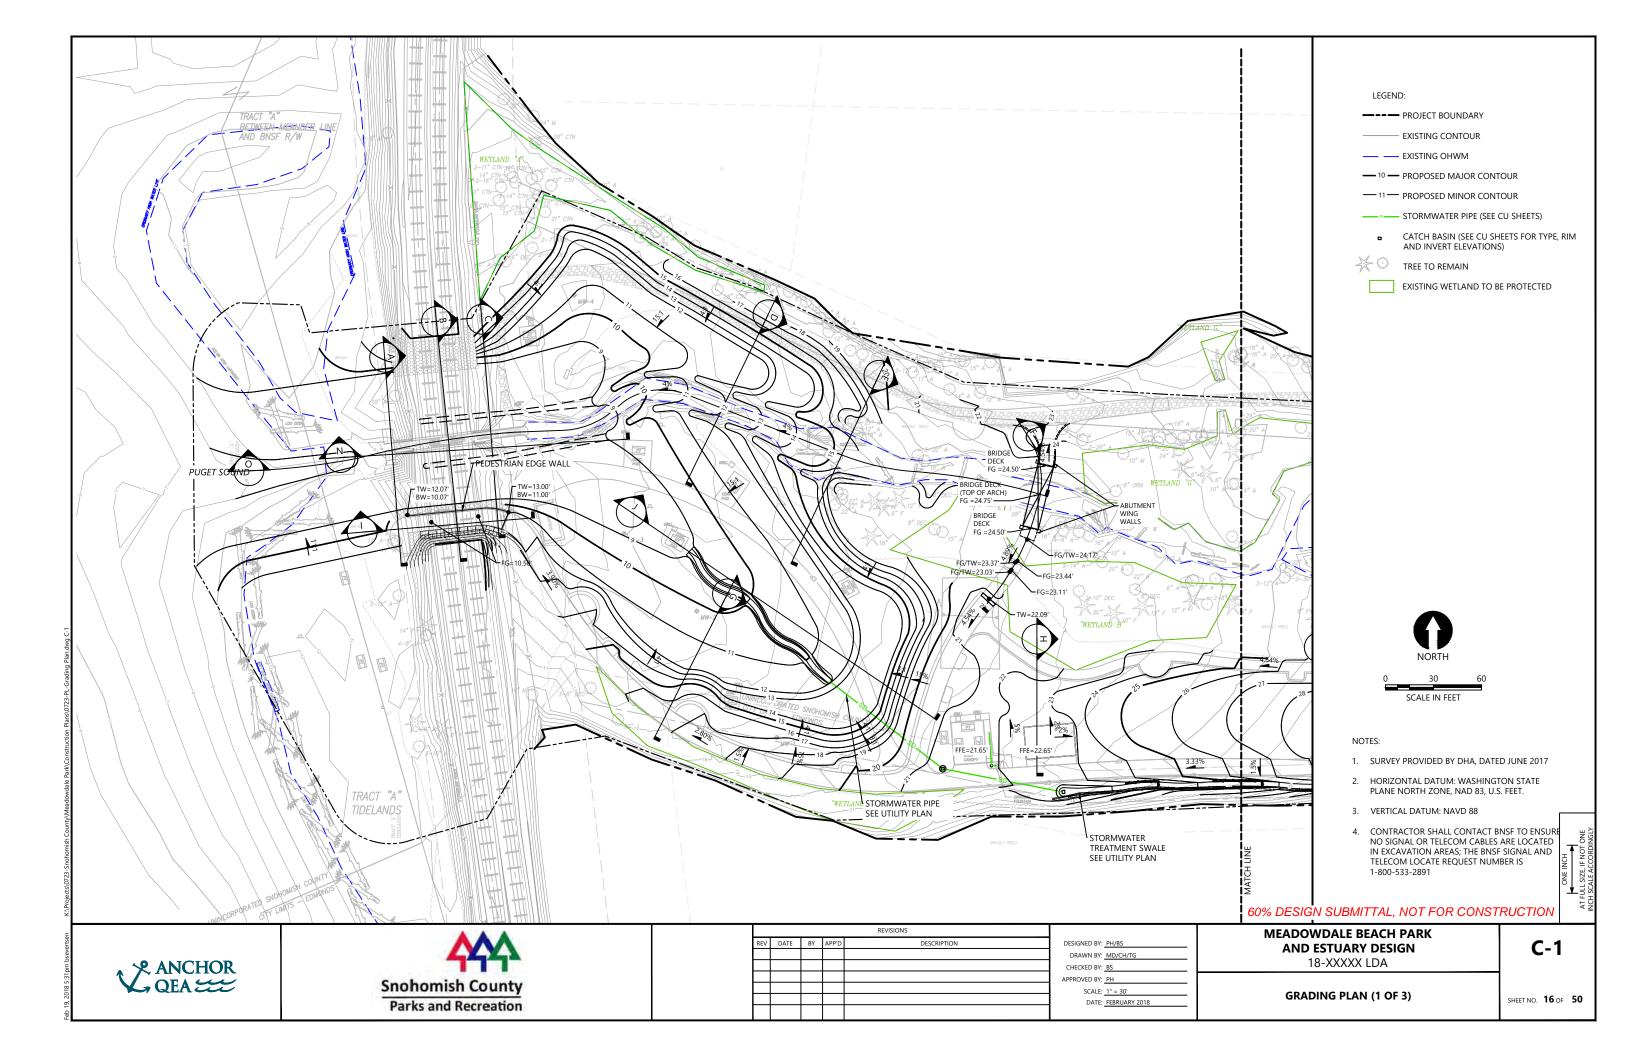

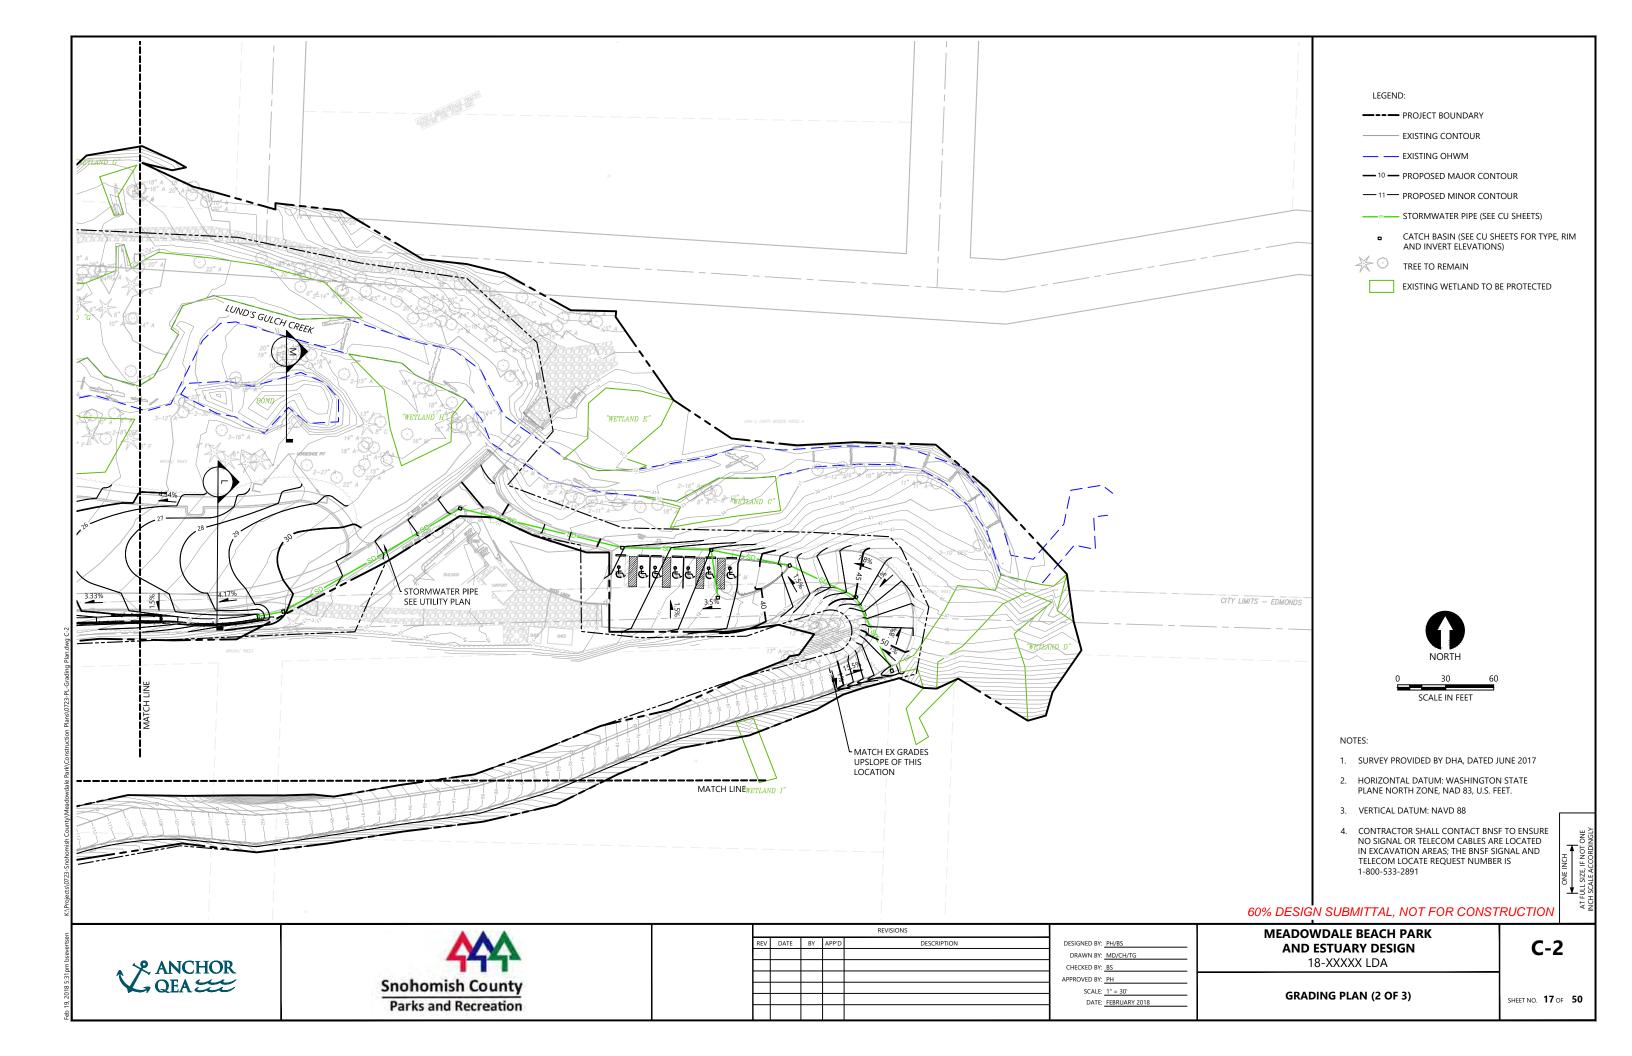


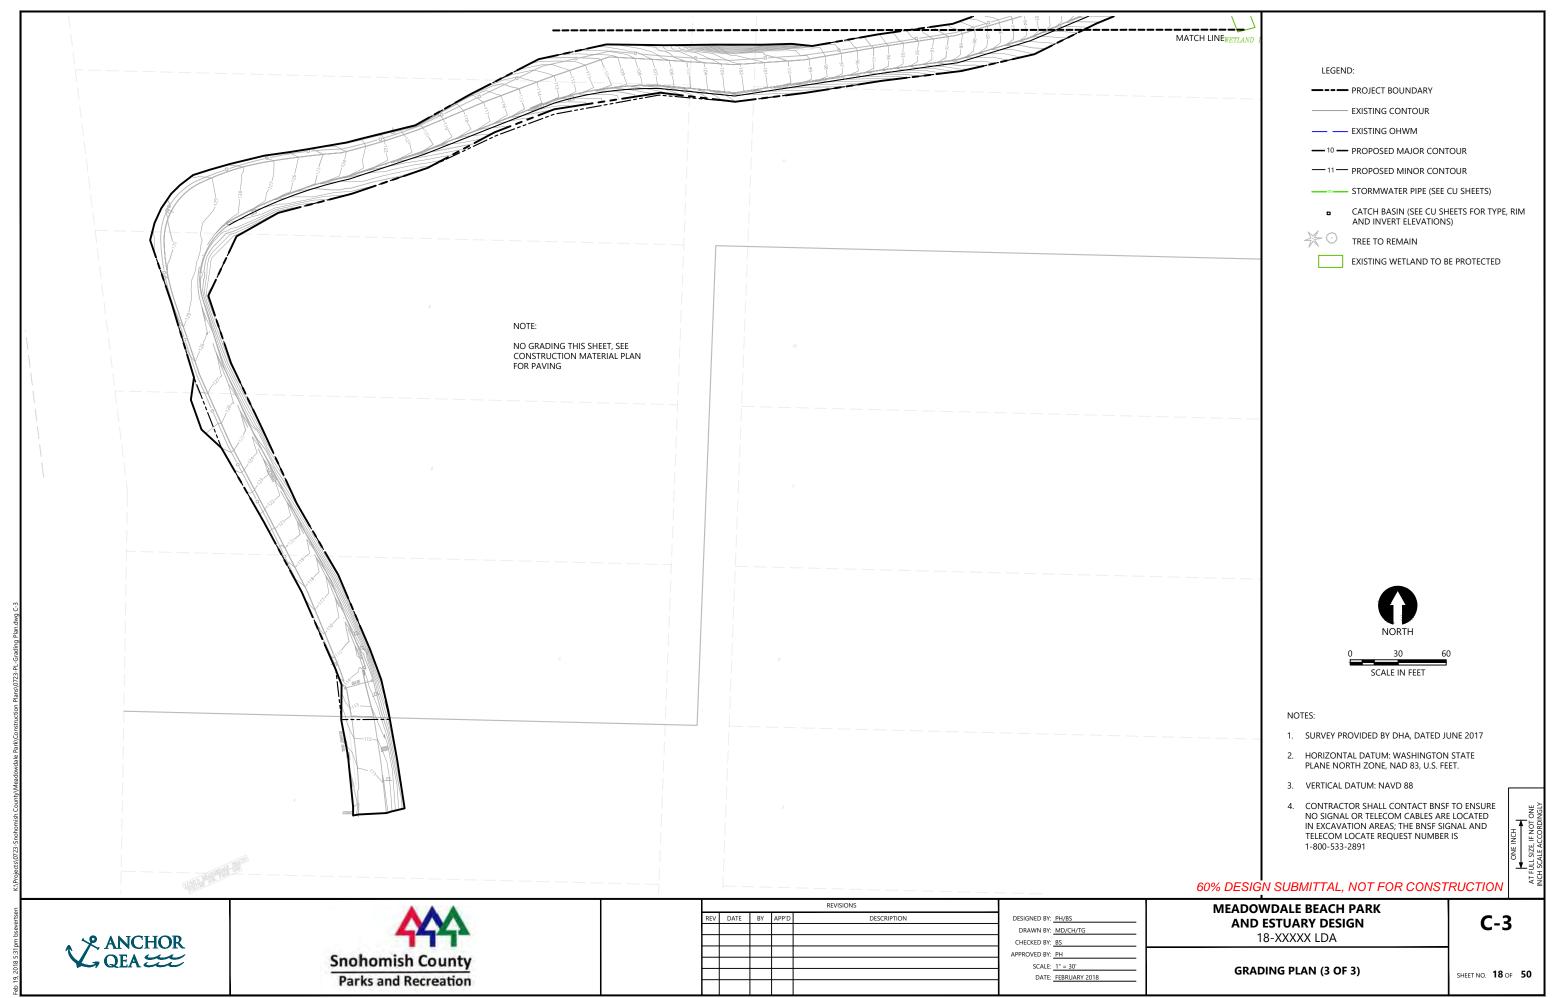


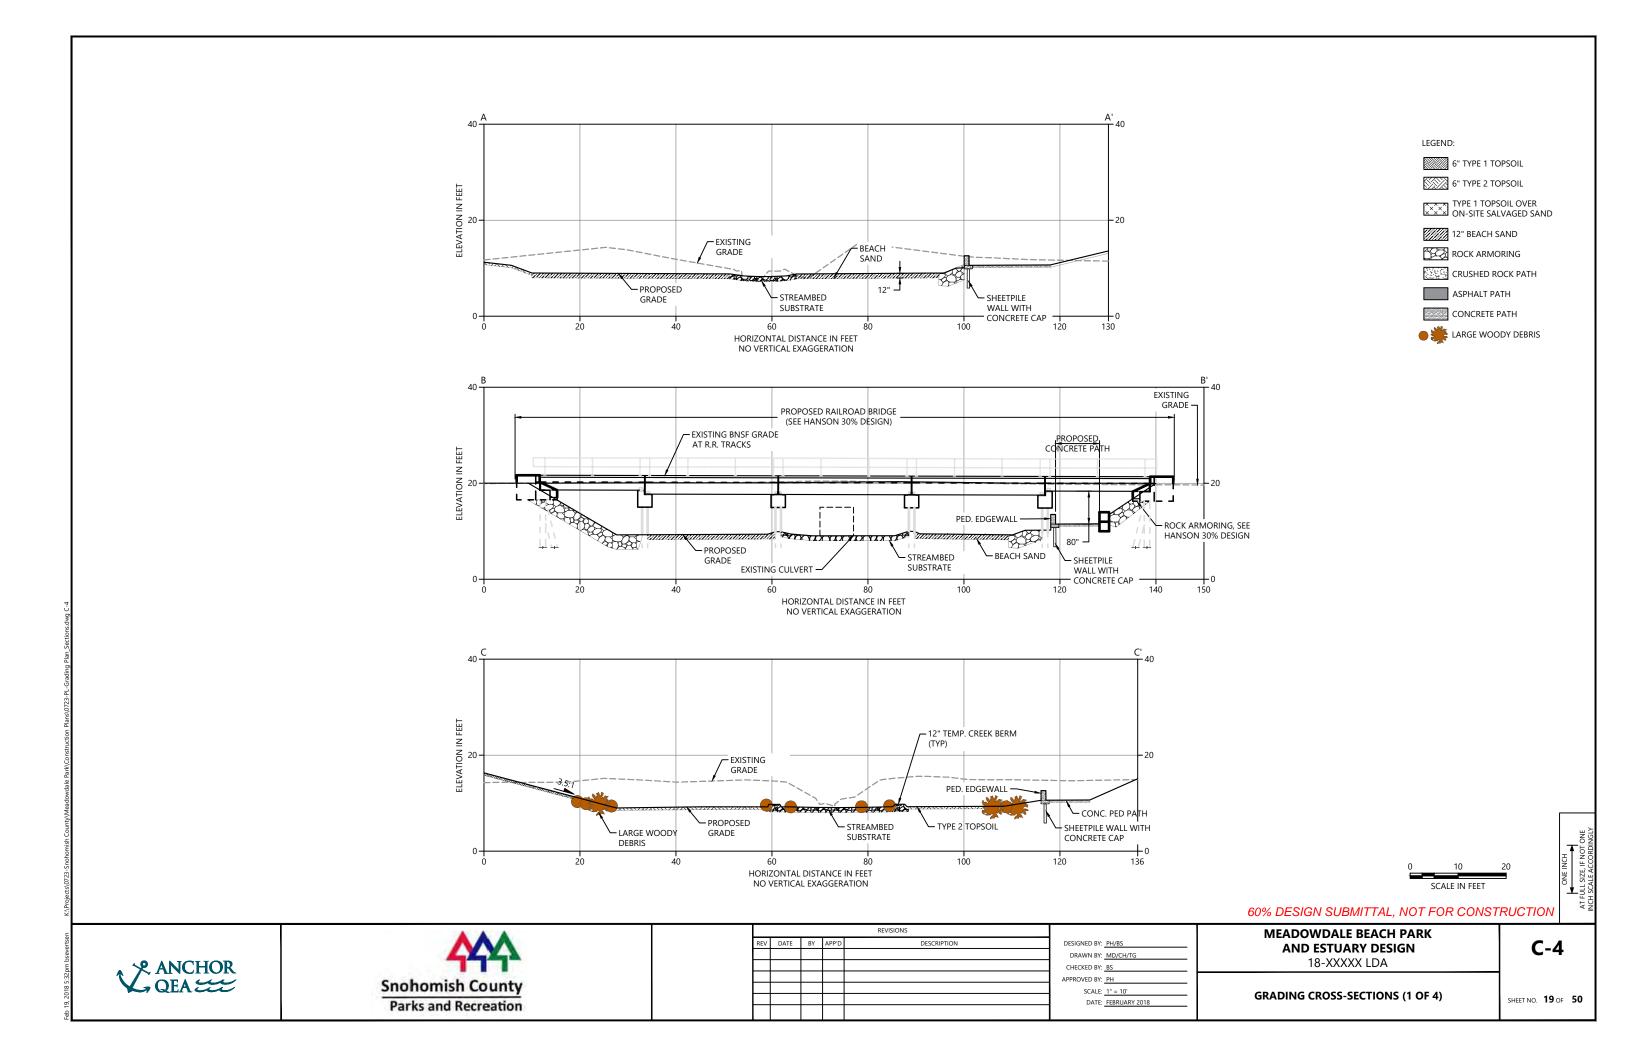


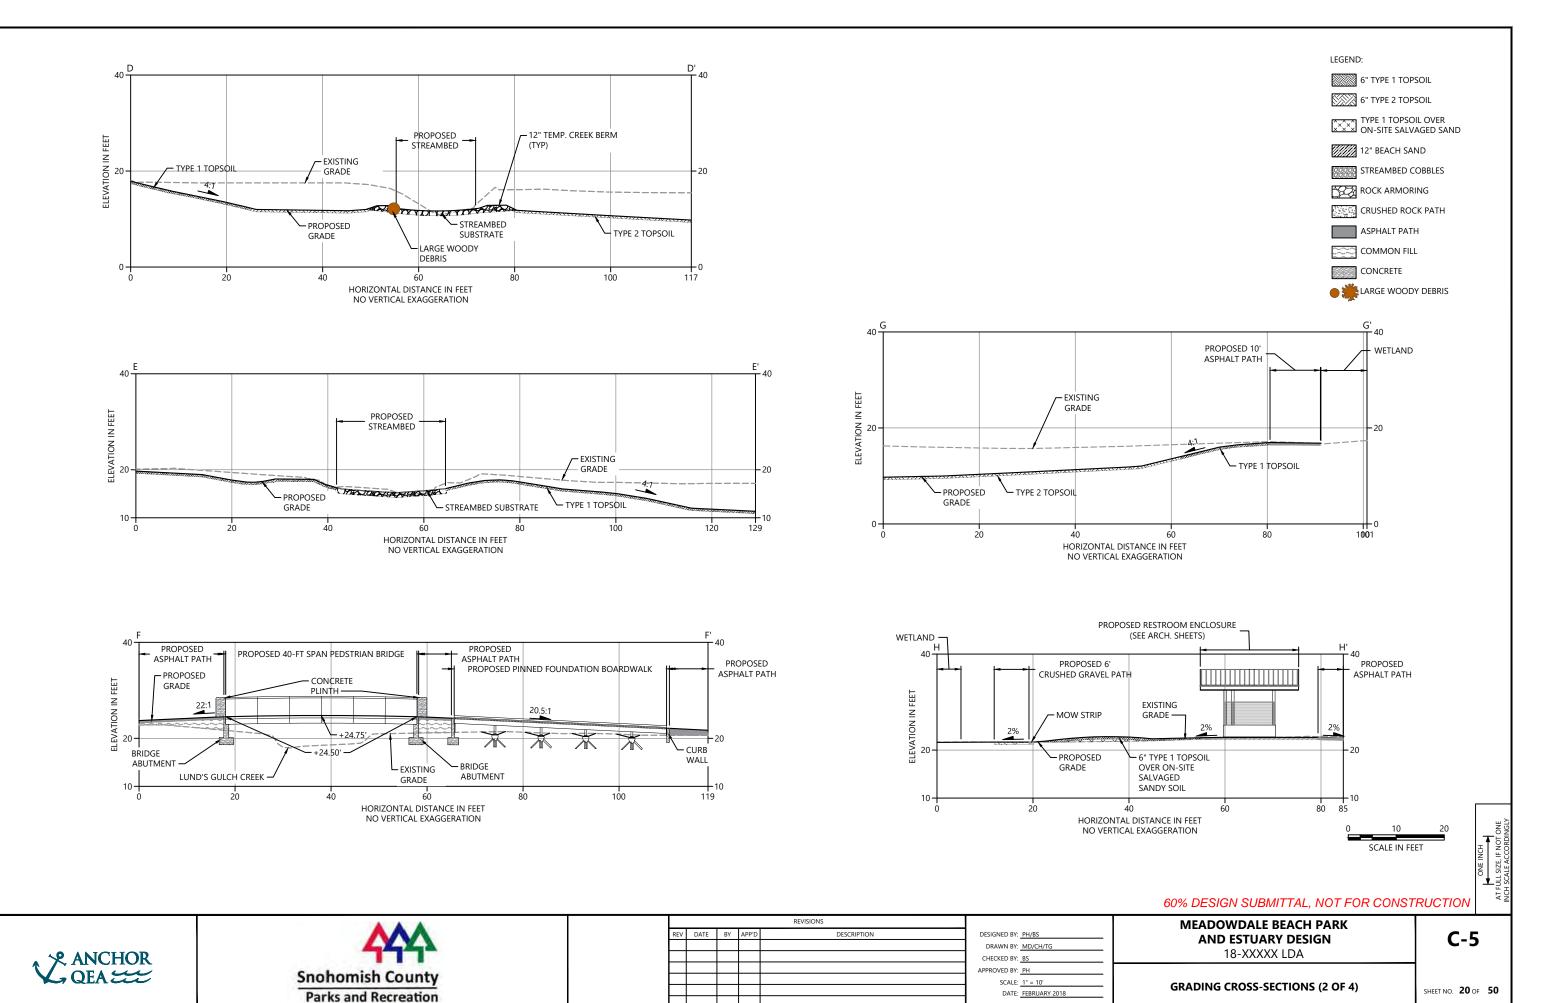


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DATE: FEBRUARY 2018
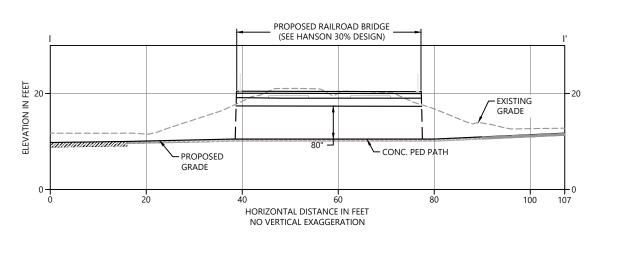
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LEGEND:

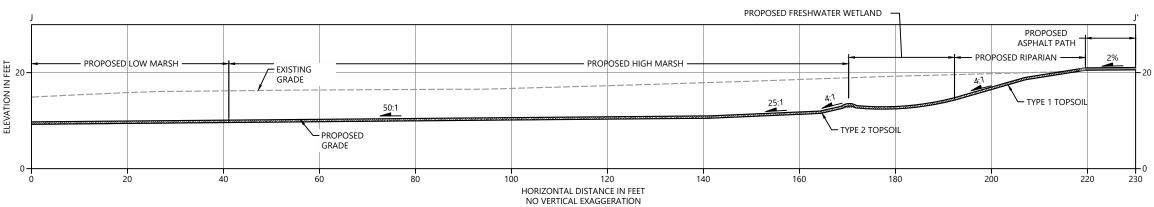6" TYPE 1 TOPSOIL 6" TYPE 2 TOPSOIL

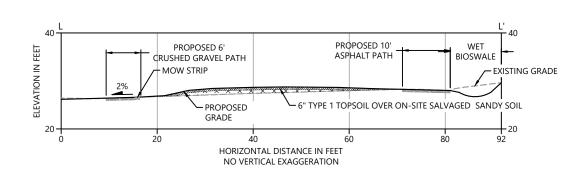12" BEACH SAND

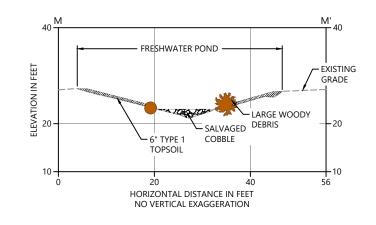ROCK ARMORING

ASPHALT PATH CONCRETE PATH ■ LARGE WOODY DEBRIS

STREAMBED COBBLES

CRUSHED ROCK PATH OR TRENCH

TYPE 1 TOPSOIL OVER ON-SITE SALVAGED SAND

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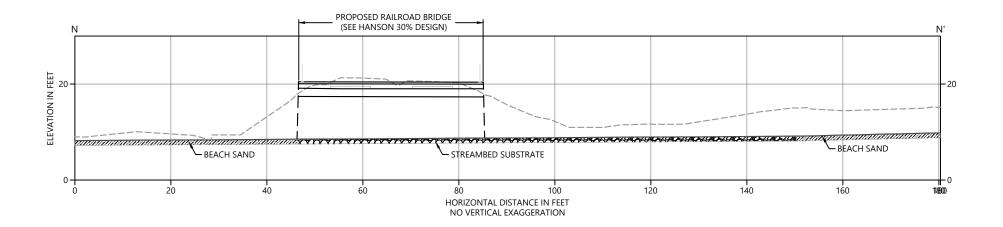
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**MEADOWDALE BEACH PARK AND ESTUARY DESIGN** 18-XXXXX LDA


**GRADING CROSS-SECTIONS (3 OF 4)** 

**C-6** 

SHEET NO. 21 OF 50





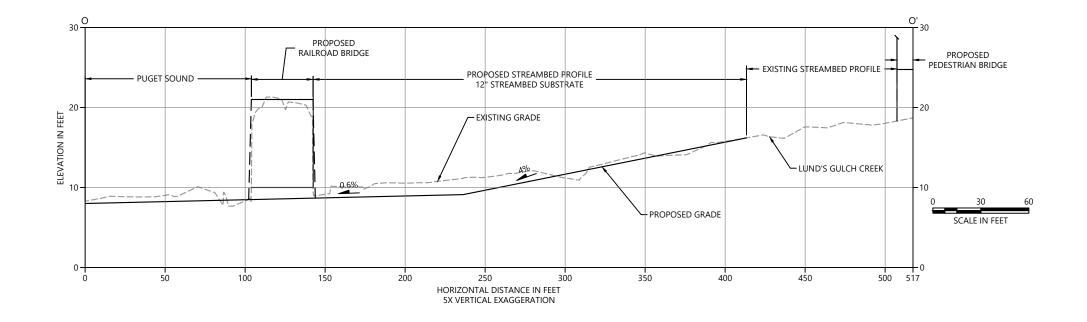

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ANCHOR QEA




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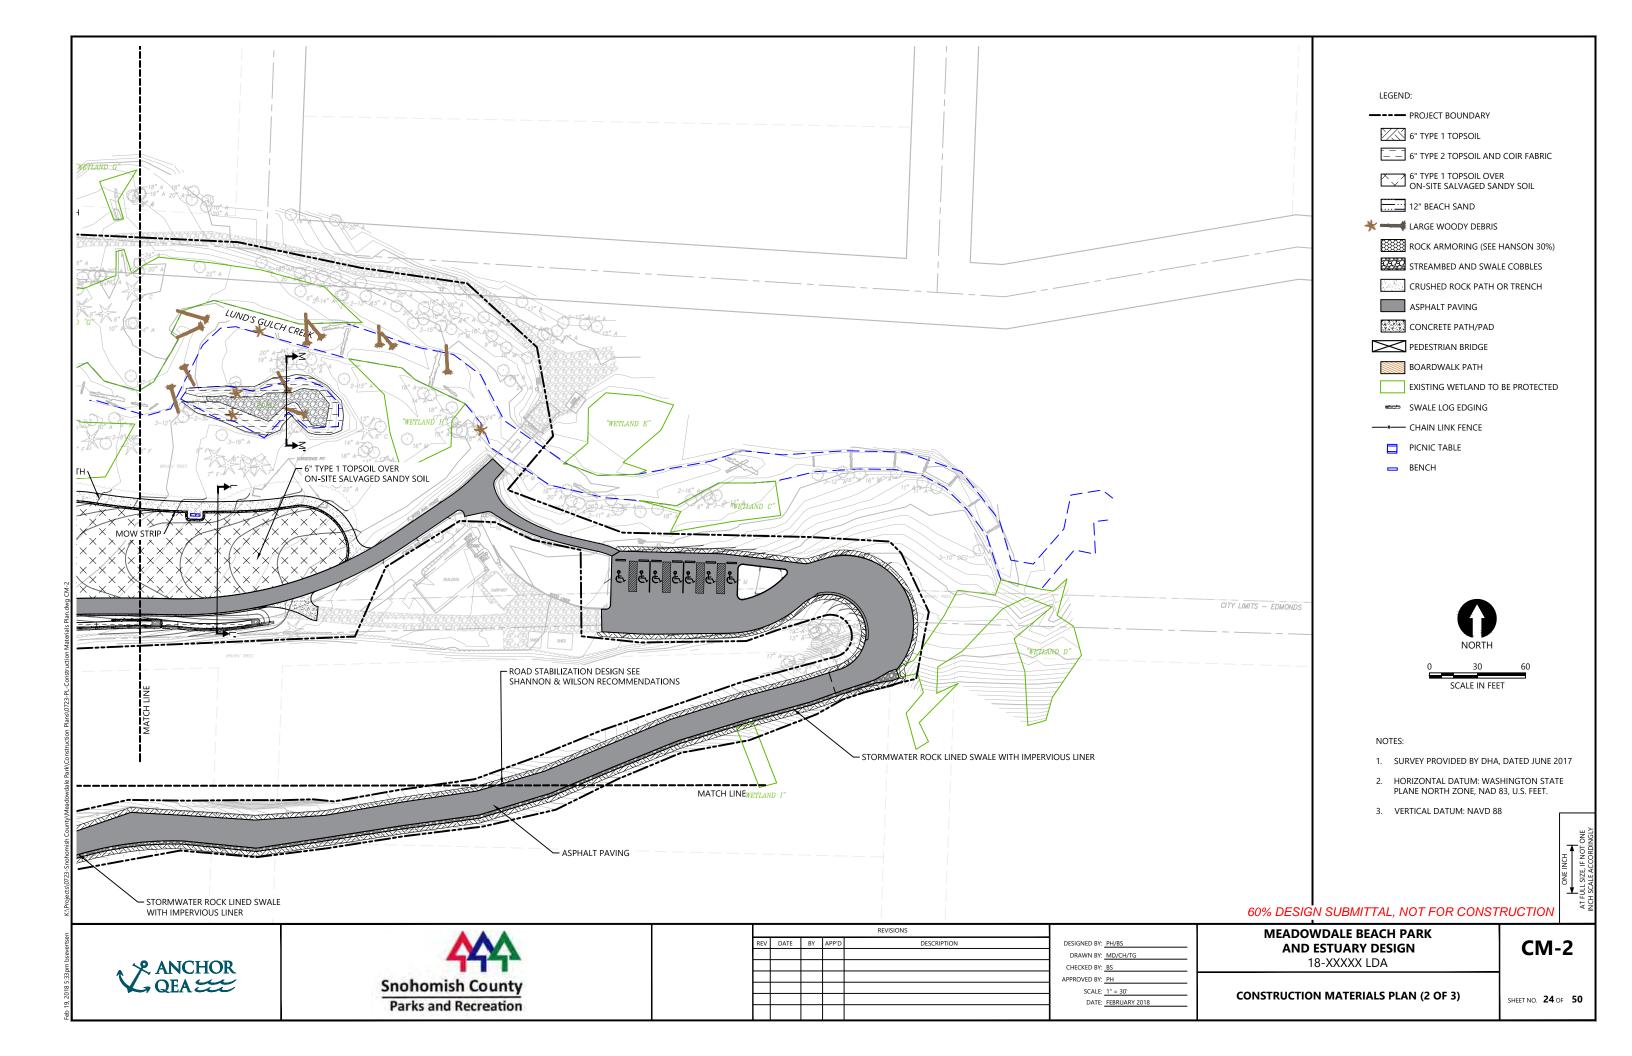
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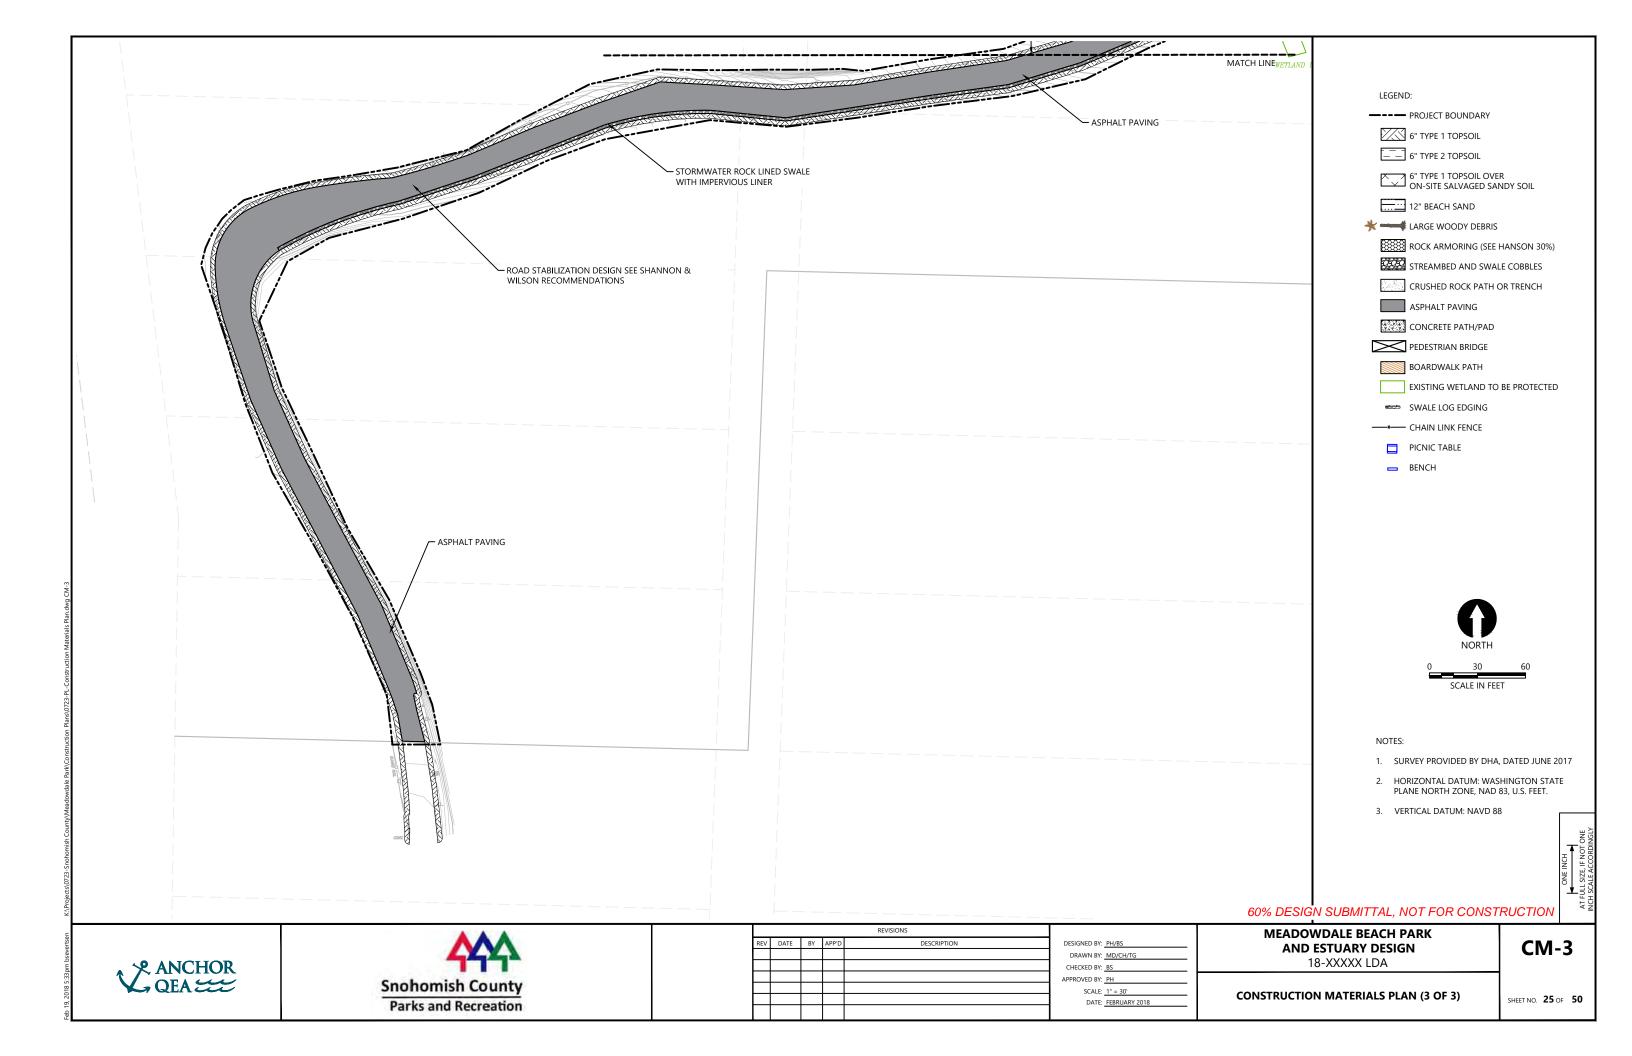
**GRADING CROSS SECTIONS (4 OF 4)** 


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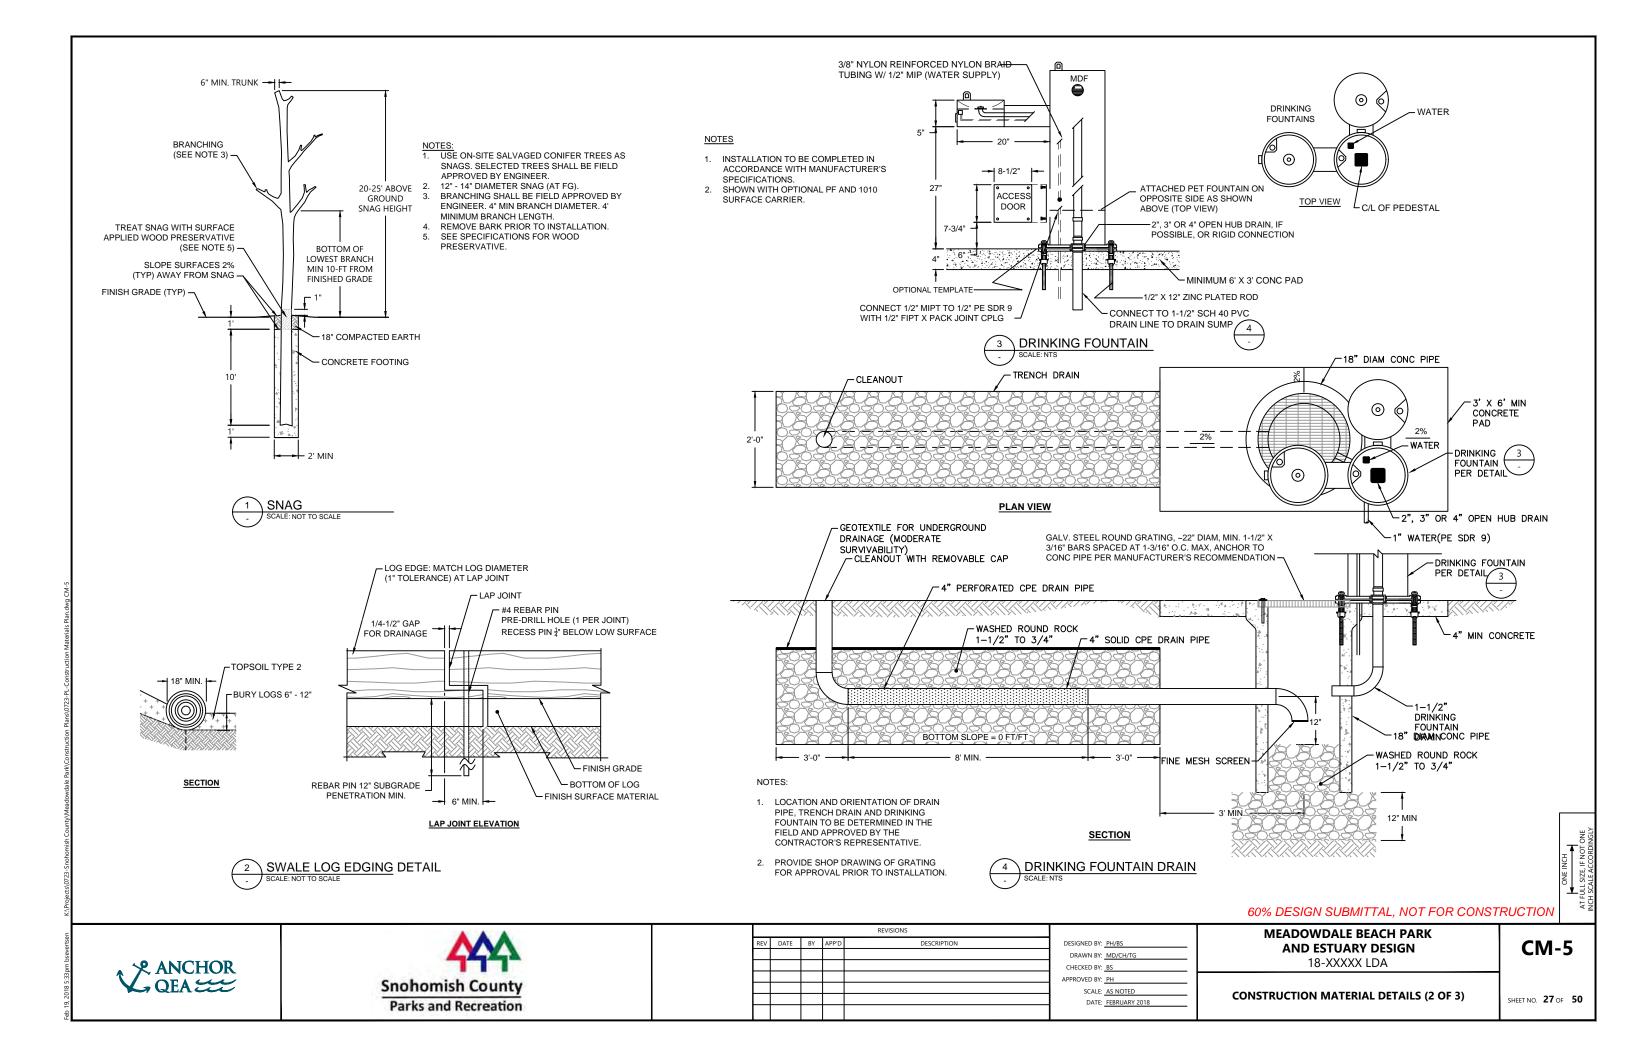
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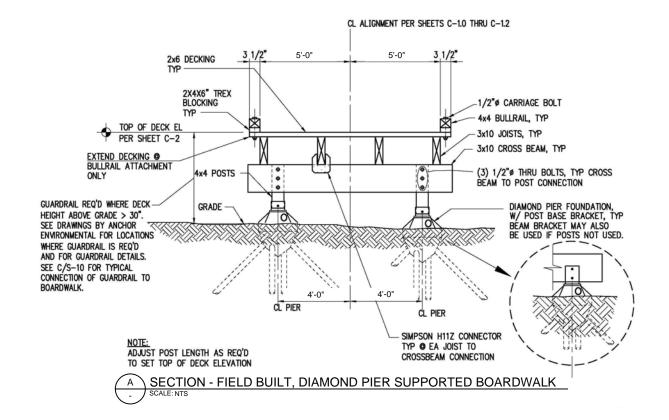










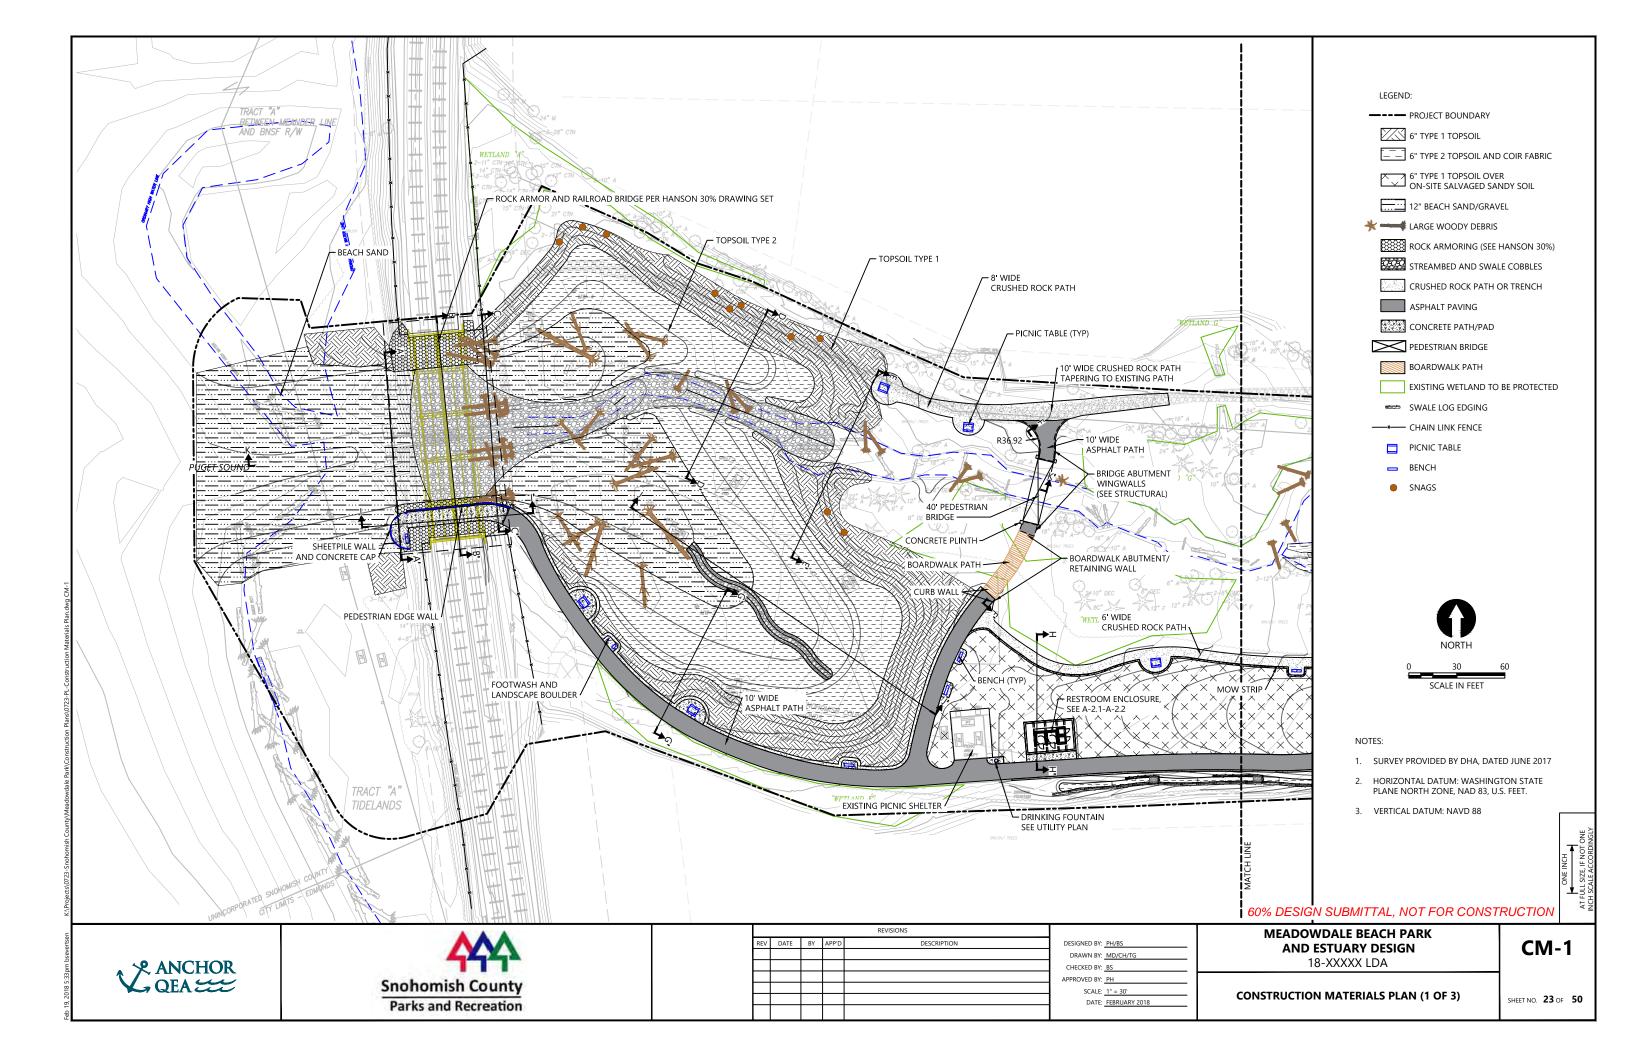

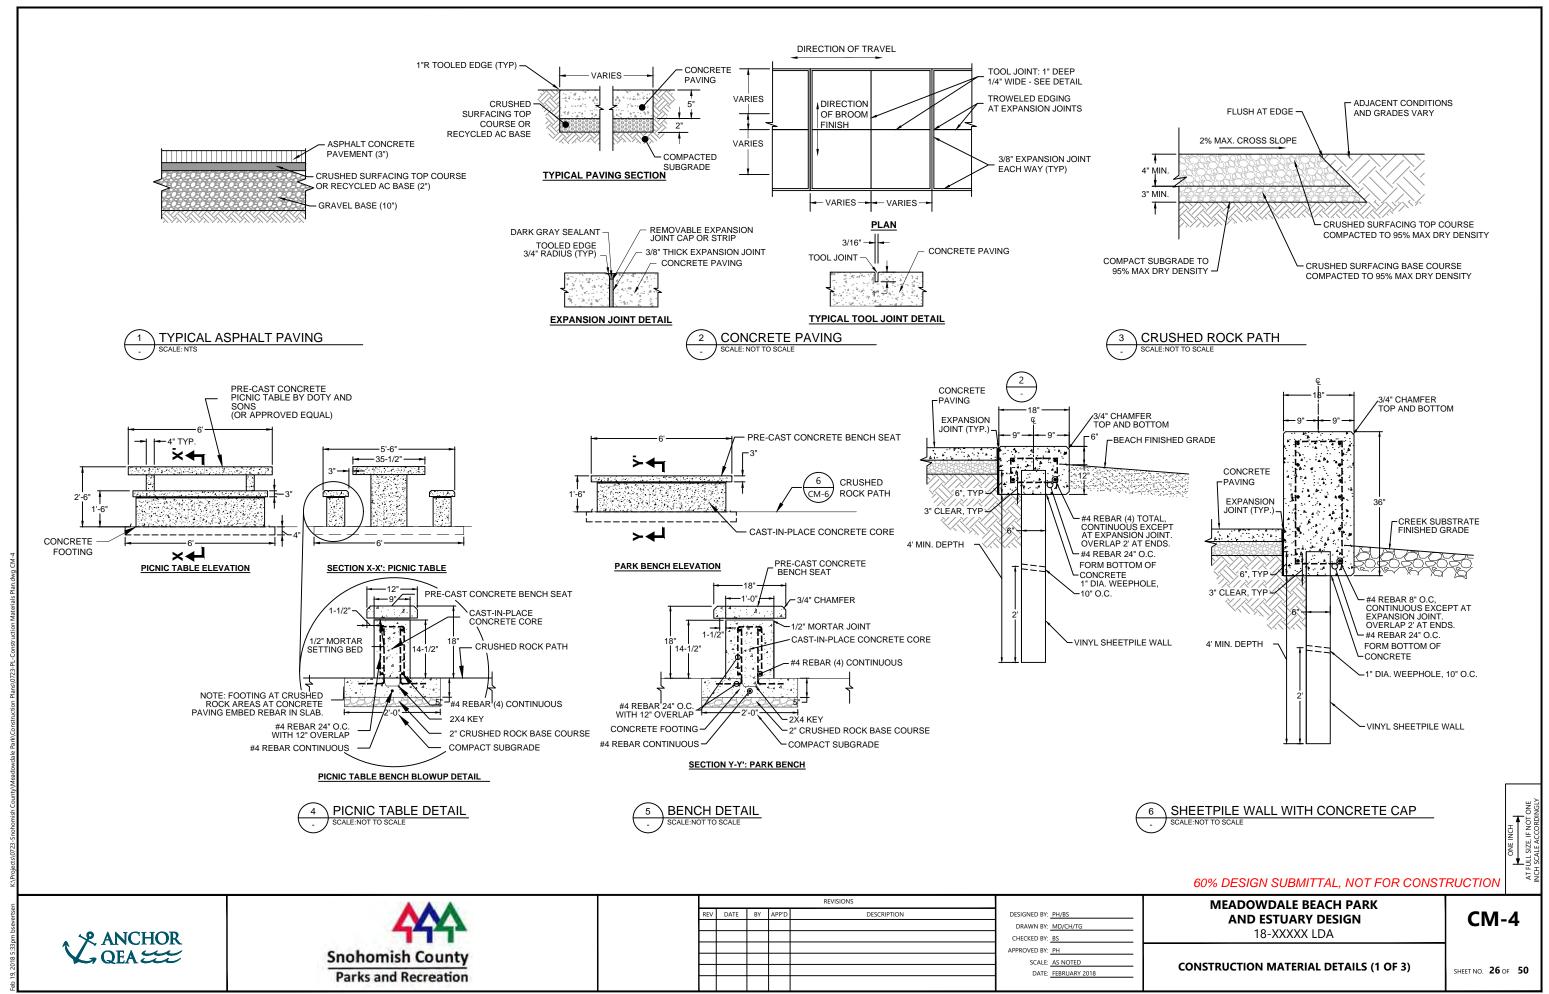

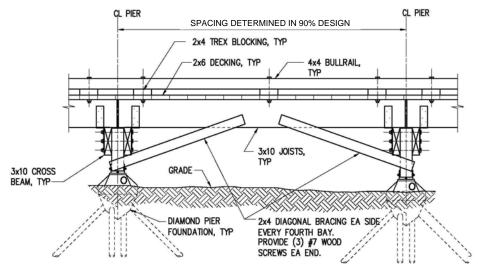

B ELEVATION - FIELD BUILT, DIAMOND PIER SUPPORTED BOARDWALK

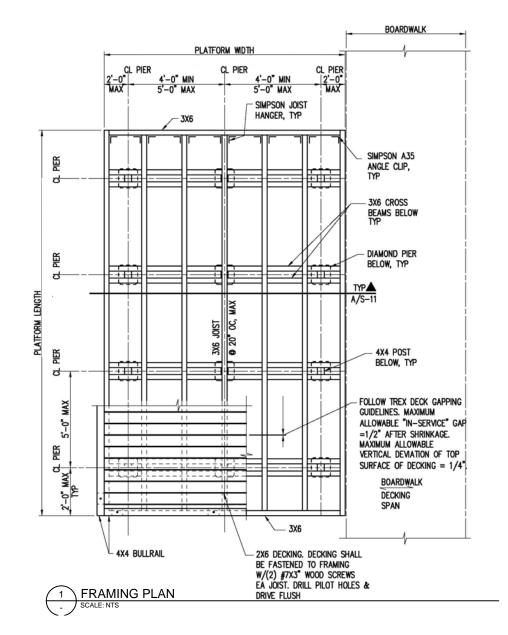

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ANCHOR QEA



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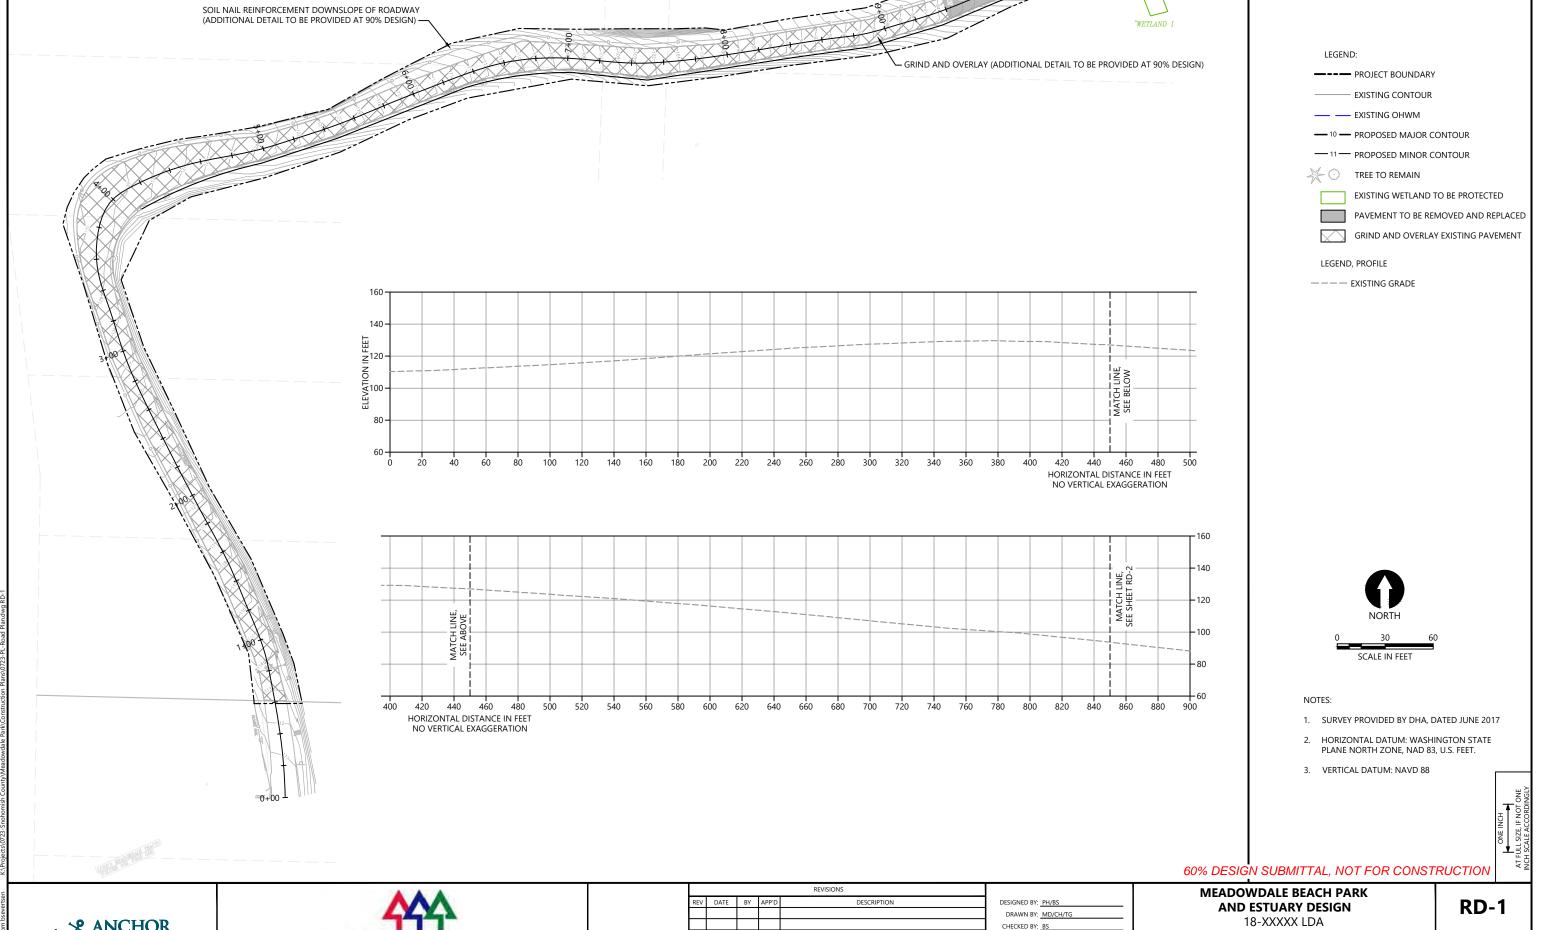
**CONSTRUCTION MATERIAL DETAILS (3 OF 3)** 

SHEET NO. 28 OF 50

**MEADOWDALE BEACH PARK** DESIGNED BY: PH/BS

SCALE: AS NOTED

DATE: FEBRUARY 2018







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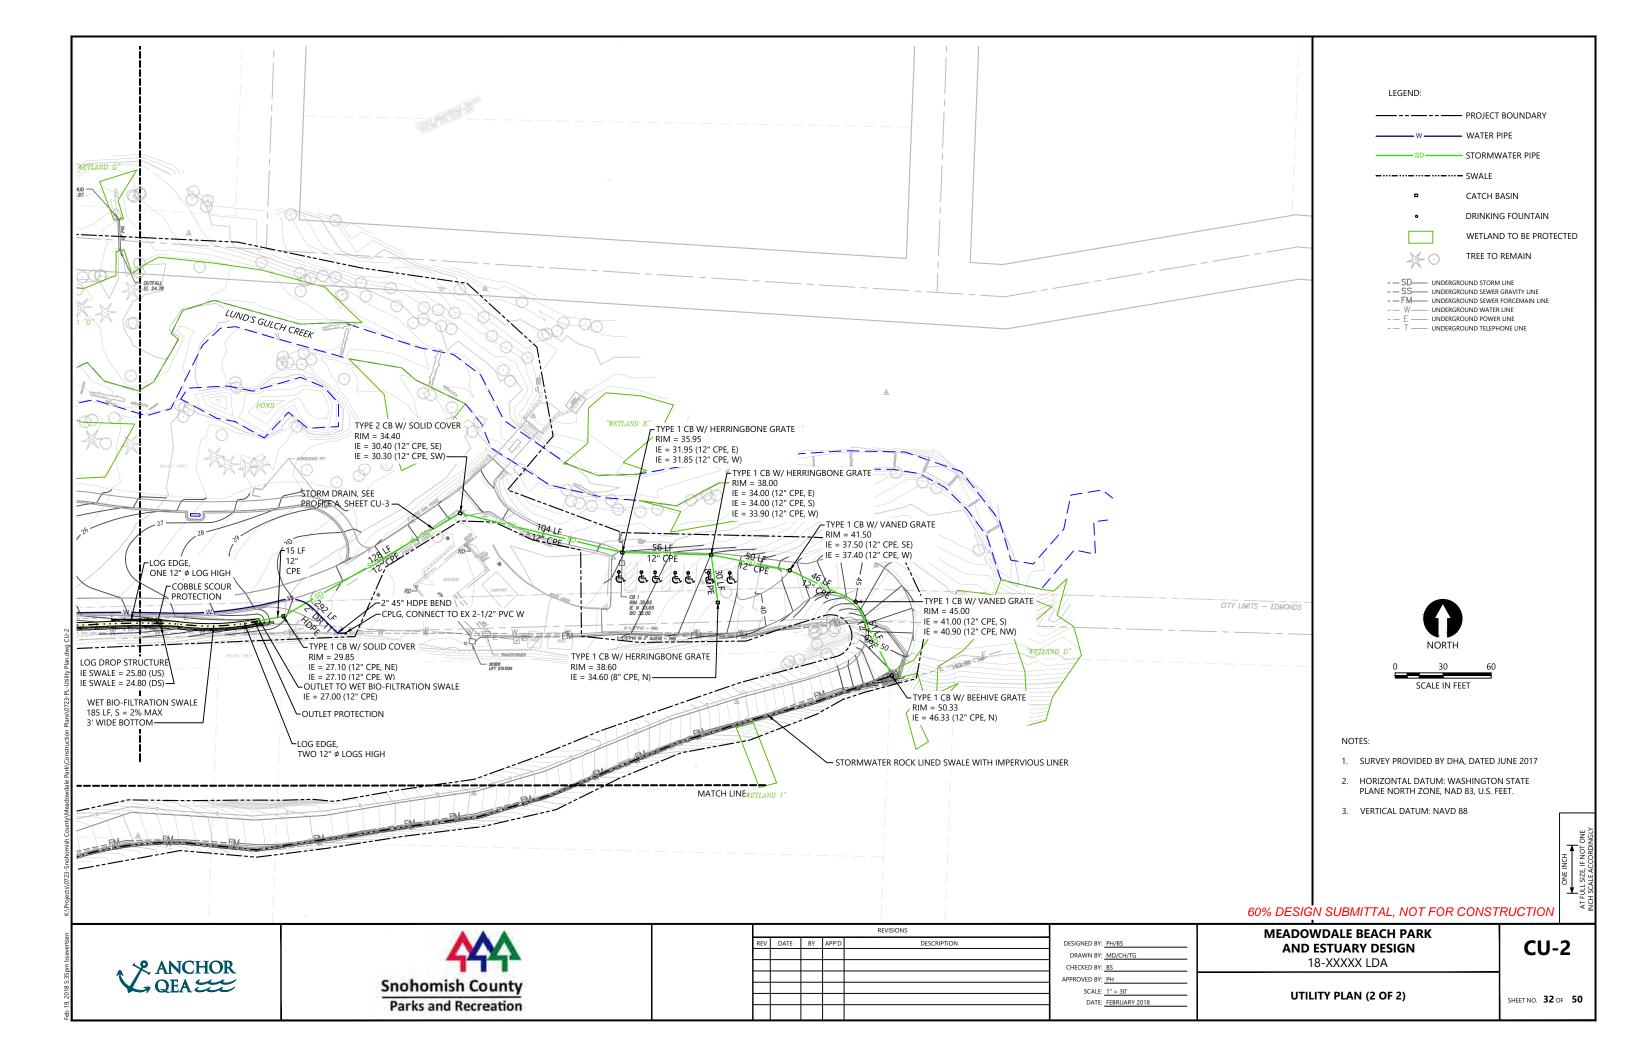
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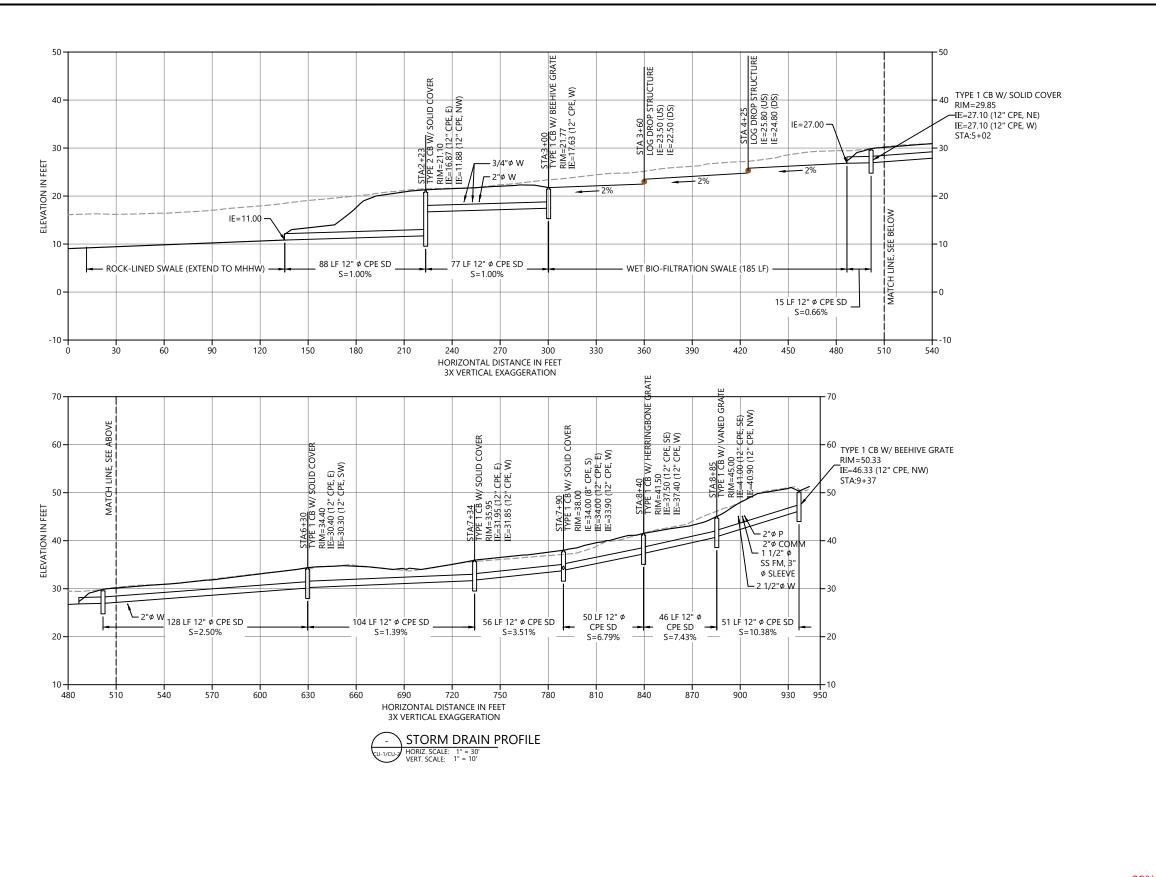
**ROADWAY PLAN (1 OF 2)** 

SHEET NO. 29 OF 50





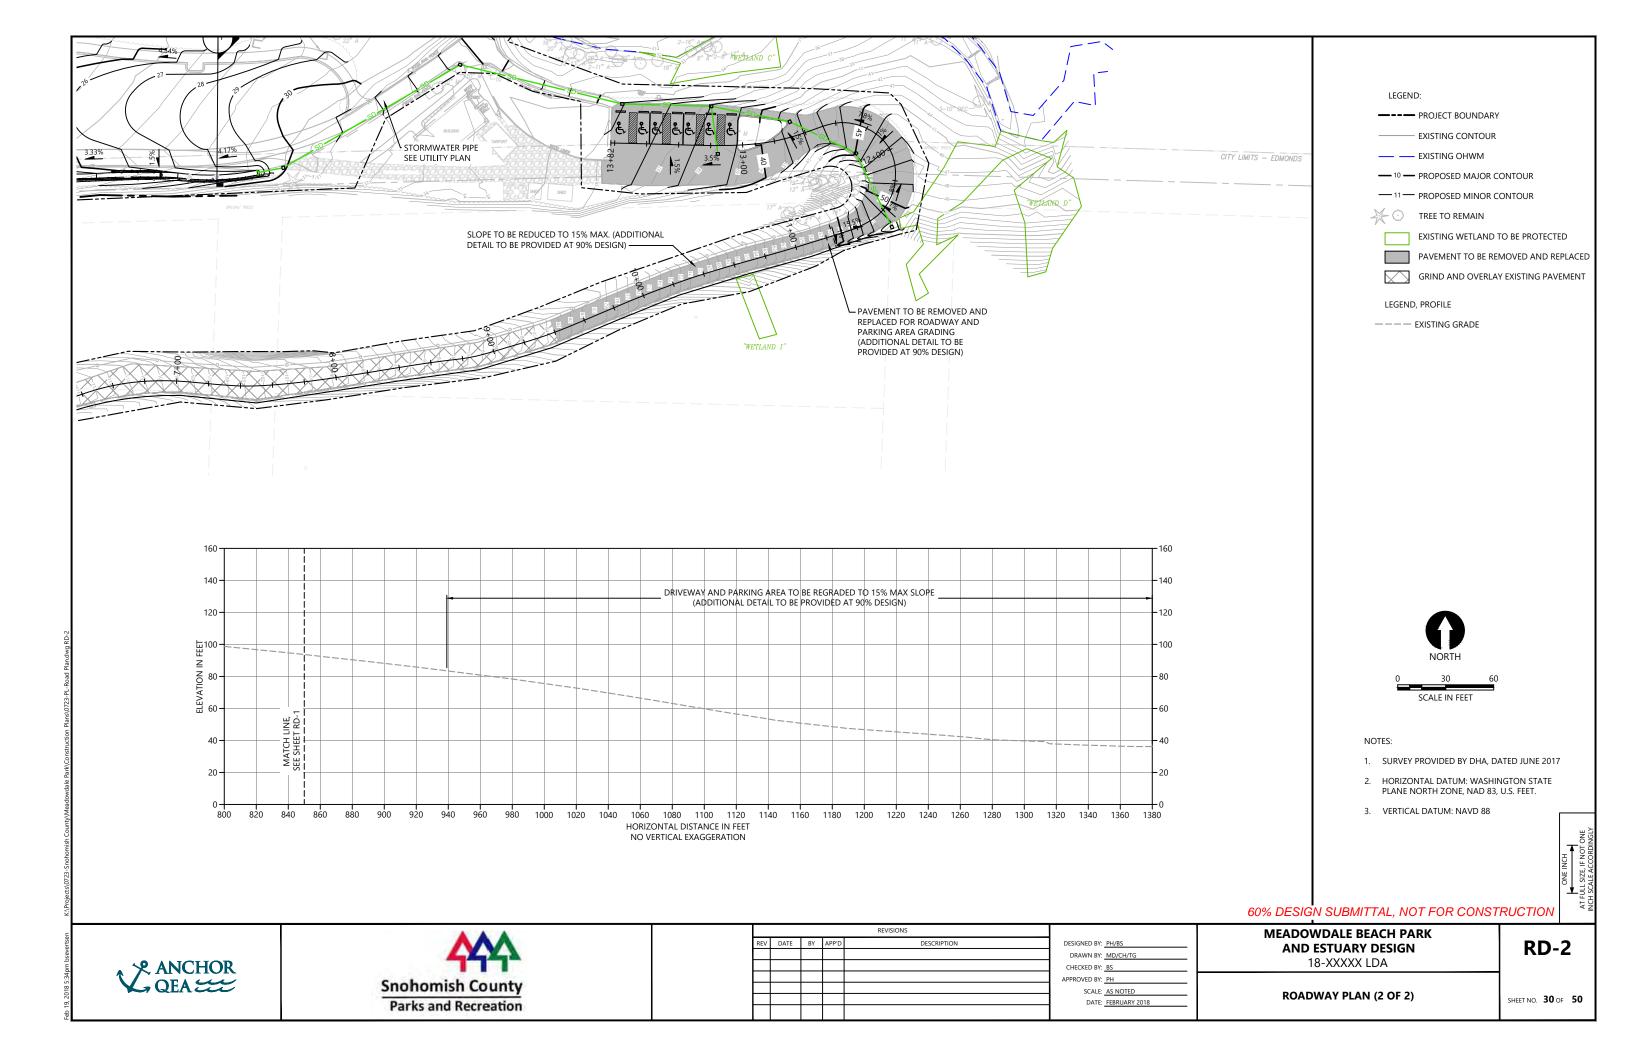

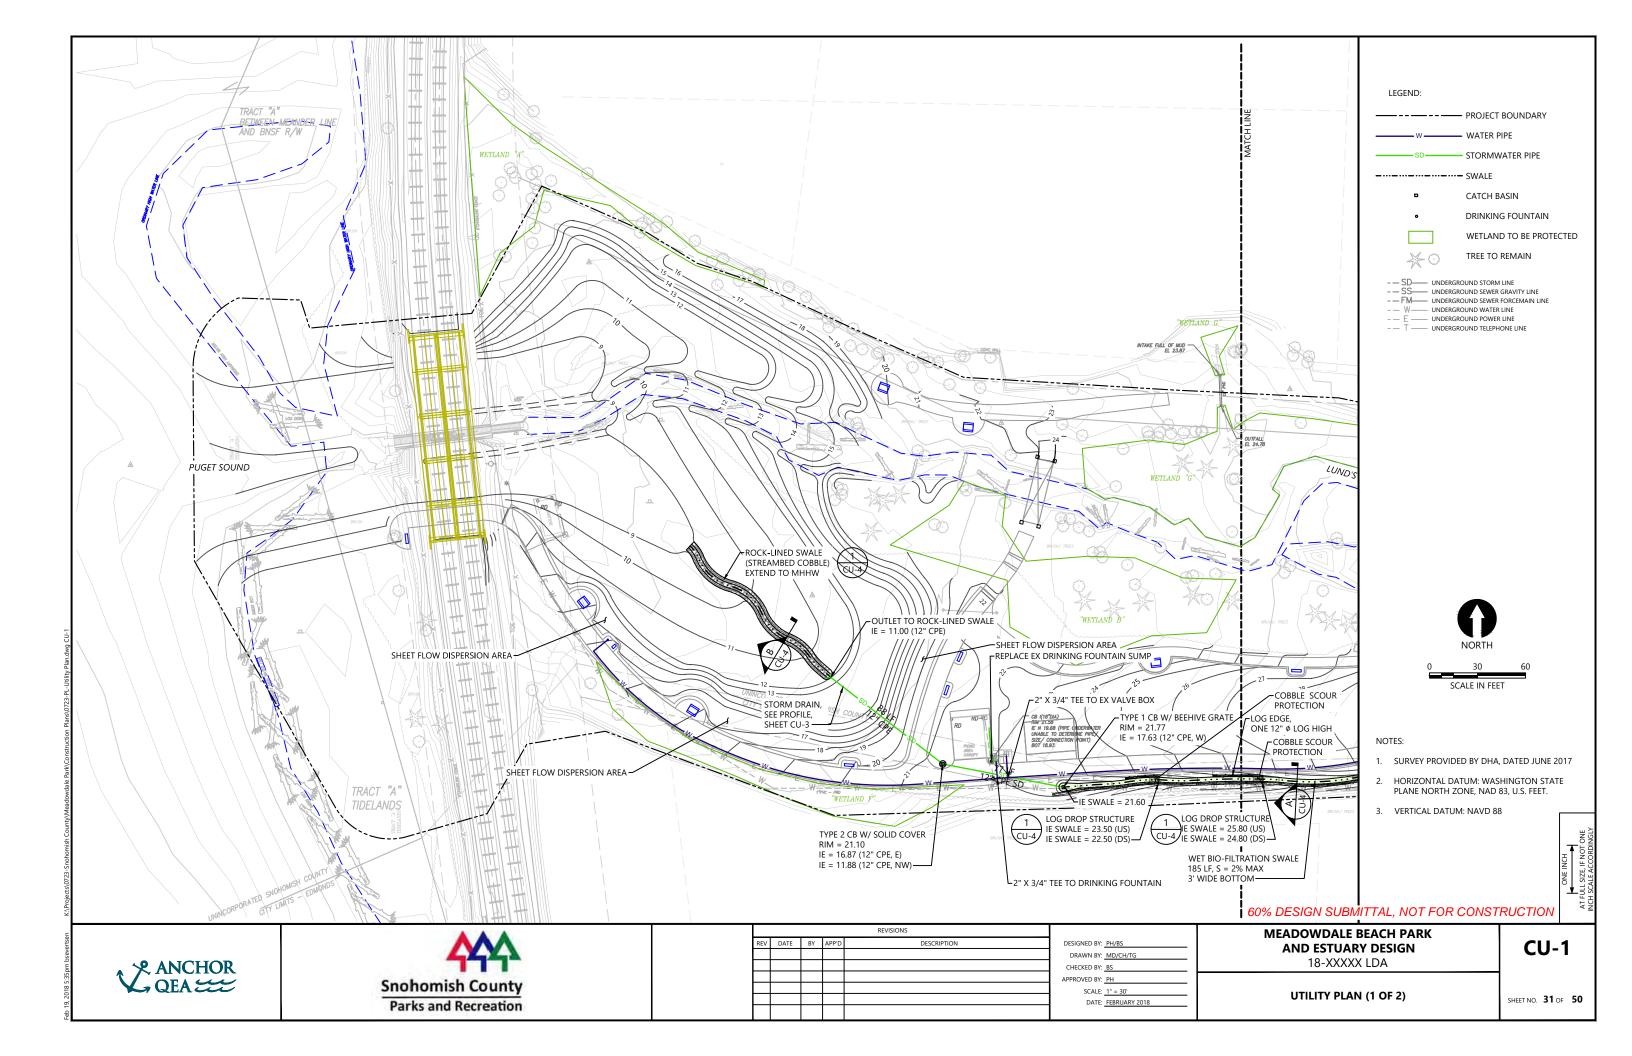

LEGEND, PROFILE

---- EXISTING GRADE

PROPOSED GRADE

NOTES:

1. SURVEY PROVIDED BY DHA, DATED JUNE 2017

SCALE IN FEET

- 2. HORIZONTAL DATUM: WASHINGTON STATE PLANE NORTH ZONE, NAD 83, U.S. FEET.
- 3. VERTICAL DATUM: NAVD 88

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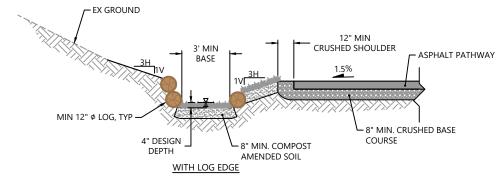
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APPROVED BY:	PH	
SCALE:	AS NOTED	
DATE:	FEBRUARY 2018	


**MEADOWDALE BEACH PARK AND ESTUARY DESIGN** 18-XXXXX LDA

STORM DRAIN PROFILE

CU-3


SHEET NO. 33 OF 50



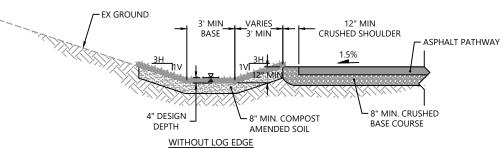


A TYPICAL WET BIO-FILTRATION SWALE SECTION


C-12 SCALE: 1" = 3"

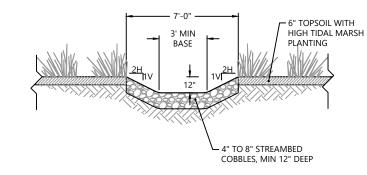

B TYPICAL OUTFALL SWALE SECTION

C-12 SCALE: 1" = 3"

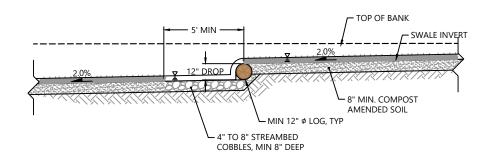

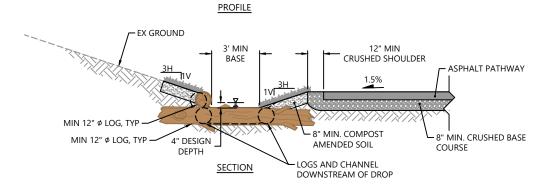

1 BIO-FILTRATION SWALE - LOG DROP DETAIL

C-12 SCALE: 1" = 3'

#### NOTES:

- 1. SURVEY PROVIDED BY DHA, DATED JUNE 2017
- 2. HORIZONTAL DATUM: WASHINGTON STATE PLANE NORTH ZONE, NAD 83, U.S. FEET.
- 3. VERTICAL DATUM: NAVD 88

60% DESIGN SUBMITTAL, NOT FOR CONSTRUCTION





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**MEADOWDALE BEACH PARK** SIGNED BY: PH/BS **AND ESTUARY DESIGN** DRAWN BY: MD/CH/TG HECKED BY: BS ROVED BY: PH SCALE: AS NOTED DATE: FEBRUARY 2018

18-XXXXX LDA

**DRAINAGE DETAILS** 

SHEET NO. 34 OF 50

CU-4

#### **GENERAL NOTES**

- 1. ALL WORK SHALL BE IN CONFORMANCE WITH APPLICABLE CODES AND LOCAL BUILDING REQUIREMENTS, INCLUDING BUT NOT LIMITED TO THE 2015 EDITION OF THE IBC AND THE 2015 INTERNATIONAL ENERGY CONSERVATION CODE AS ADOPTED BY WA
- 2. ALL APPLICABLE CODES, ORDINANCES AND MINIMUM STRUCTURAL REQUIREMENTS TAKE PRECEDENCE OVER DRAWINGS AND NOTES.
- 3. CONTRACTOR SHALL VERIFY ALL DIMENSIONS SHOWN ON THE DRAWINGS BEFORE COMMENCING WITH WORK. ANY DISCREPANCIES SHALL BE BROUGHT TO THE ATTENTION OF THE OWNER AND ARCHITECT PRIOR TO STARTING ANY CONSTRUCTION OF THE AREA CONCERNED. DO NOT SCALE DRAWINGS
- 4. DIMENSIONS ARE TO FACE OF FRAMING OR CONCRETE U.O.N.
- 5. PARTITIONS AND WALLS NOT OTHERWISE DIMENSIONED SHALL BE LOCATED FLUSH WITH REFERENCE TO ADJACENT WALL FACE.
- 6. WHERE ON ANY OF THE DRAWINGS OR DETAILS, A PORTION OF THE WORK IS SHOWN AND/OR DETAILED, AND THE REMAINDER IS INDICATED IN OUTLINE THE PARTS SHOWN AND/OR DETAILED SHALL APPLY TO ALL OTHER LIKE PORTIONS OF THE WORK.
- 7. PRIOR TO AND DURING THE WORK, CONTRACTOR SHALL VERIEY CONDITIONS: ANY CONDITIONS INCONSISTENT OR PROBLEMATIC WITH REGARD TO THE INTENT OF THE DRAWINGS SHALL BE BROUGHT TO THE ATTENTION OF THE OWNER AND ARCHITECT PRIOR TO STARTING OR CONTINUING WORK IN THE AREA CONCERNED.
- 8. PROVIDE SUFFICIENT STRUCTURE IN WALLS FOR SUPPORTING COUNTERS, CABINETS, ACCESSORIES, ETC., AS REQUIRED.
- 9. COORDINATE AND PROVIDE REQUIRED PENETRATIONS (AND PATCHING OF EXISTING TO MATCH) WITH INDIVIDUAL SUBCONTRACTORS TO SUIT NEW WORK.
- 10. VERTICAL DIMENSIONS ARE TYPICALLY REFERENCED FROM STRUCTURAL SLAB U.N.O.
- 11. AT FIRE RATED WALLS OR CEILING ASSEMBLIES WHERE PENETRATIONS FOR MECH., ELECT., OR PLUMBING OCCUR, PROVIDE APPROVED THRU PENETRATION FIRE STOP ASSEMBLIES. MAINTAIN REQUIRED RATING OF ASSEMBLIES.
- 12. CONTRACTOR TO ASSUME ALL MATERIALS AS NEW UNLESS NOTED AS "EXISTING".
- 13. PRESSURE TREAT ALL WOOD IN CONTACT WITH
- 14. FLASH OPENINGS WITH MIN, 26 GA, STAINLESS STEEL TO ACCEPTABLE INDUSTRY STANDARDS. ALL FLASHING LAP SEAMS TO BE 12" MIN. W/ 2 BEADS OF SEALANT.
- 15. GLASS WITHIN 18" OF FLOOR AND ADJACENT TO DOORS AND AT HAZARDOUS LOCATIONS SHALL COMPLY WITH IBC IMPACT LOAD REQUIREMENTS, SECTION 5406, AND
- 16. CONTRACTOR TO PROVIDE & INSTALL SMOKE DETECTORS. VERIFY LOCATION W/OWNER AND ARCHITECT PRIOR TO INSTALLATION.
- 17. CONTRACTOR TO VERIFY LOCATION OF ALL EXISTING UTILITIES THROUGHOUT SITE PRIOR TO EXCAVATION.

- 18. BACKPRIME ALL EXTERIOR WOOD TRIM MATERIAL WHERE PAINTED, SEALER WHERE NOT PAINTED (ALL SIDES, EDGES AND CUT ENDS) PER WWPA AND WRCLA
- 19. VAPOR RETARDER PRIMER TO BE UTILIZED AT INTERIOR DRYWALL @ ALL EXTERIOR WALLS AND ROOF
- 20. AT ALL DOORS AND WINDOWS: FULL ROUGH OPENING WRAP INCLUDING SILL PAN FLASHING U.N.O. SUBSILL FLASHING WO WRAP OVER ROUGH SILL AND 4-6" MIN. UP SIDE JAMBS. WATER BARRIER MEMBRANE AT ALL OPENINGS. CLOSED CELL BACKER ROD AND SEALANT AT AIR SEALS AROUND ALL WINDOWS.
- 21. WEATHER RESISTIVE BARRIER TO HAVE OVERLAP AS DIRECTED BY MFG.
- 22. WEATHER RESISTIVE BARRIER TO BE INSTALLED OVER TOP PLATE PRIOR TO SETTING OF RAFTERS OR ROOF TRUSSES, S.S. FASTENERS WHEN IN CONTACT WITH PT
- 23. STAINLESS STEEL NAILS OR FASTENERS TO USED AT ALL APPLICATIONS WHERE NAILS OR FASTENERS ARE EXPOSED TO EXTERIOR.
- 24. SUBSILLL FLASHING AT ALL DOORS EXPOSED TO WEATHER, SEE NOTE #20 FOR OPENING WRAP.
- 25. CONTRACTOR TO ENSURE ADEQUATE INSULATION COVERAGE OVER RECESSED LIGHTING FIXTURES.
- 26. ALL RECESSED LIGHTS, SPRINKLER HEADS ETC. TO BE SEALED WITH CAULK OR GASKETS; SERVICE PENETRATIONS AT TOP WALL PLATES AND VERTICAL CHASES TO BE SEALED TO PREVENT AIR LEAKAGE.

#### SCOPE OF WORK

CONSTRUCTION OF NEW COVERED AREA FOR PORTABLE RESTROOMS.

#### CODE COMPLIANCE

- 2015 INTERNATIONAL BUILDING CODE (IBC) W/ WA STATE AMENDMENTS
- ICC A117.1-2009 ACCESSIBLE AND USABLE BUILDING
- 2015 WASHINGTON STATE ENERGY CODE (WSEC) (2015 INTERNATIONAL ENERGY CONSERVATION CODE W/ WA STATE AMENDMENTS)
- 2015 INTERNATIONAL FIRE CODE (IFC)
- 2015 NATIONAL ELECTRICAL CODE (NÉC) 2015 INTERNATIONAL MECHANICAL CODE (IMC)
- 2015 UNIFORM PLUMBING CODE (UPC)

#### FIRE RESISTANCE RATING

STRUCTURAL FRAME NON-RATED BEARING WALLS, EXT. NON-RATED BEARING WALLS, INT. NON-RATED NONBEARING WALLS EXT NON-RATED NONBEARING WALLS, EXT. NON-RATED FLOOR CONSTRUCTION NON-RATED ROOF CONSTRUCTION NON-RATED

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REVISIONS DESCRIPTION DATE: <u>02/07/18</u>


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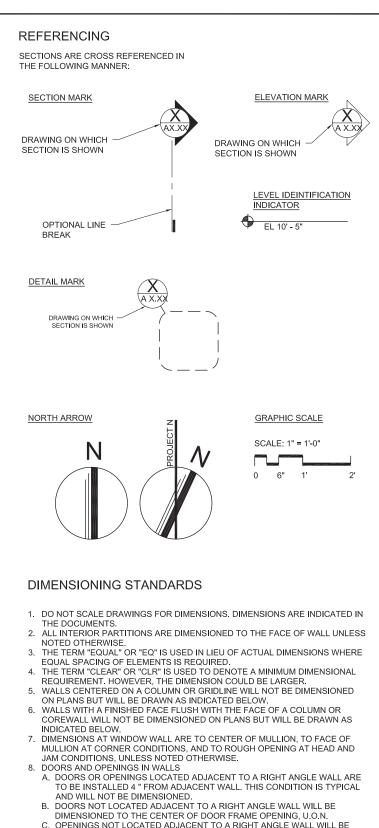
**MEADOWDALE 60% SUBMITTAL** 

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ARCHITECTURE GENERAL INFORMATION

SHEET NO. 350F 50



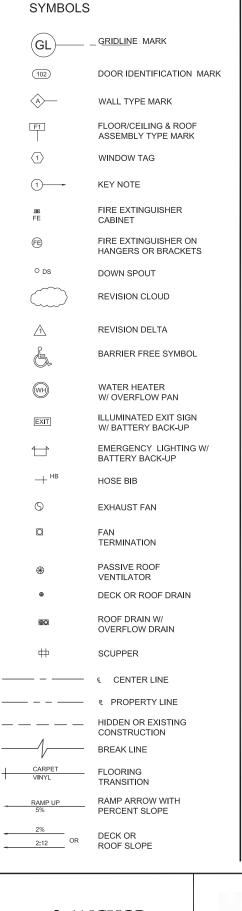

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9. ALL HEIGHTS ARE DIMENSIONED FROM THE TOP OF THE STRUCTURAL

(T.O.S.S.) SLAB UNLESS NOTED OTHERWISE


## MATERIALS EARTH SURFACE SAND / GROUT 4 4 CONCRETE WOOD OR METAL STUD WALLS GYPSUM BOARD CONT. WOOD FRAMING WOOD BLOCKING FINISHED WOOD BATT INSULATION RIGID INSULATION BOARD BRICK CONCRETE UNIT MASONRY STEEL RESILIENT TILES

#### **ABBREVIATIONS** ANCHOR BOLT FIBER REINFORCED CONCRETE POWER ROOF VENT AIR CONDITIONING FOOD STORAGE BUILDING PSF LBS PER SQUARE FOOT A/C FSB ACOUSTICAL CEILING TILE FT PTD PAPER TOWEL DISPENSER ACT FFFT ADJC ADJUSTABLE FTG FOOTING QT QUARRY TILE AFF ABOVE FINISH FLOO FTR FINNED TUBE RADIATION RADIUS, RISER AIR HANDLING UNIT FURN FURNITURE, FURNACE RAD RADIATOR AHU REINFORCED CONCRETE ALUM ALUMINUM GΑ GAGE APT APARTMENT GALV GALVANIZED RCP REINFORCED CONCRETE PIPE BD BOARD GI GALVANIZED IRON RD ROOF DRAIN BEE BOTTOM FOOTING ELEVATION GENERAL CONTRACTOR RECPT RECEPTACIE GC BITUM BITUMINOUS GL GLASS, GLAZING REINF REINFORCED BLDG BUILDING GND GROUND RET RETAINING ROUND HEAD MACHINE BLK BLOCK GR GRADE BLKG BLOCKING MACHINE GRL **GRILLE** RHWS ROUND HEAD WOOD GRAVITY ROOF VENT GRV BM BEAM RM ROOM BOT BOTTOM GYPSUM WALL BOARD RΩ ROUGH OPENING GWB RAINWATER LEADER BRG BEARING GWT GLAZED WALL TILE RWL BUR BUILT-UP ROOFING GYP GYPSUM SD SOAP DISPENCER CAB CABINET HORIZ HORIZONTAL SECT SECTION CARPET HANDICAPPED STRUCTURAL FACING TILE HC CH BD CHALKBOARD HDR SHR SHOWER **HEADER** CEM CEMENT HDWD HARDWOOD SHT SHEET CHANNEL HEX HEAD MACHINE SCREW SIM CHAN HHMS SIMII AR CJ CONSTRUCTION JOINT НМ HOLLOW METAL SMS SHEET METAL SCREW CENTER LINE H PT HIGH POINT SND SAN. NAPKIN DISPENSER CL HNDRL SNR SANITARY NAPKIN RECEPTACLE CLOSET HANDRAIL CLG CEILING HGT HEIGHT SPACE CMU CONCRETE MASONRY UNIT HR SPEC SPECIFICATION HOUR CERAMIC MOSAIC TILE HEATING. VENTILATION & AIR SPKLR SPRINKLER CMT HVAC CO CLEAN OUT CONDITIONING SQ SQUARE COL COLUMN ID INSIDE DIAMETER SS SANITARY SEWER COMP COMPRESSION, COMPACTED INSIDE FACE S SK SERVICE SINK CONC IN CONCRETE SST STAINLESS STEEL CONT CONTINUOUS INSULATION STD STANDARD INSUL CONTR CONTRACTOR INT INTERIOR STI STEFL CONV CONVECTOR INV INVERT STRUC STRUCTURAL CORR CORRIDOR .IAN JANITOR SUSP SUSPENDED DBL DOUBLE JST JOIST SND TOP, TILE, TREAD DET JT JOINT SND TEMPORARY DF DRINKING FOUNTAIN LAM LAMINATED **TERR** TERRAZZO DIA DIAMETER LAV LAVATORY T&G TOUNGE & GROOVE DIM DIMENSION LP LOWPOINT THRESHOLD, THICK TH MATI DISP DISPENSER MATERIAL TOD TOP OF DECK DN **DOWN** MAX MAXIMUM TOJ TOP OF JOIST DO DITTO MB MARKER BOARD TOS TOP OF STEEL DR DRAIN, DOOR MECH MECHANICAL TPD TOILET PAPER DISPENCER DTL DETAIL MFR MANUFACTURER TR TROWELED, TREAD DISHWASHER MH MANHOLE TS TUBULAR STEEL D/W DRAWING MIN MINIMUM MINUTE DWG TYP TYPICAL DS DOWNSPOUT MIR MIRROR UGRD UNDERGROUND DWL DOWEL MISC MISCELLANEOUS UNIT HEATER UH EΑ MO MASONRY OPENING UNO UNLESS NOTED OTHERWISE ETYLENE PROPYLENE DIENE MONOMER EPDM METAL UR URINAL EF EACH FACE MTD MOUNTED UTIL UTILITY NOT IN CONTRACT EL FI EVATION NIC VFRT VERTICAL VINYL COMP. TILE ELEC ELECTRIC NO NUMBER VCT EQUIP EQUIPMENT NS NEAR SIDE W/ **EACH WAY** OA OVER ALL WC WATER CLOSET / TOILET ELECTRIC WATER COOLER ОС ON CENTER W/D WASHER/DRYER ELVR ELEVATOR OD OUTSIDE DIAMETER WD WOOD OF. OUTSIDE FACE EXHAUST WDW WINDOW EXH OPNG OPENING WATER HEATER EXST EXISTING WH EXP JT EXPANSION JOINT PR PAIR WNSC WAINSCOAT EXT EXTERIOR PNL PANEL WO WITHOUT PART PARTITION WORKING POINT FD **PERF** PERFORATED FLOOR DRAIN FOUNDATION P/C PRECAST FDN FHMS FLAT HEAD MACHINE SCREW PLAS PLASTER FH FIRE HYDRANT PLATE PLASTIC LAMINATE FLR FLOOR P LAM FLG FLANGE PAINT

60% DESIGN SUBMITTAL NOT FOR CONSTRUCTION





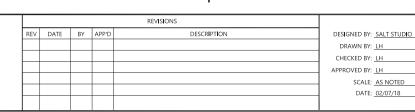

FRPF

FIREPROOF, FRAME

SCALE: AS NOTED

DATE: 02/07/18


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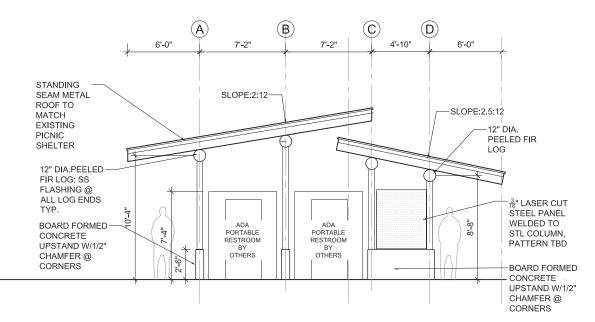
SHEET NO.  $36 \, \text{OF} \, 50$ 

A-1.1

**MEADOWDALE 60% SUBMITTAL** 

**ARCHITECTURE GENERAL NOTES** 



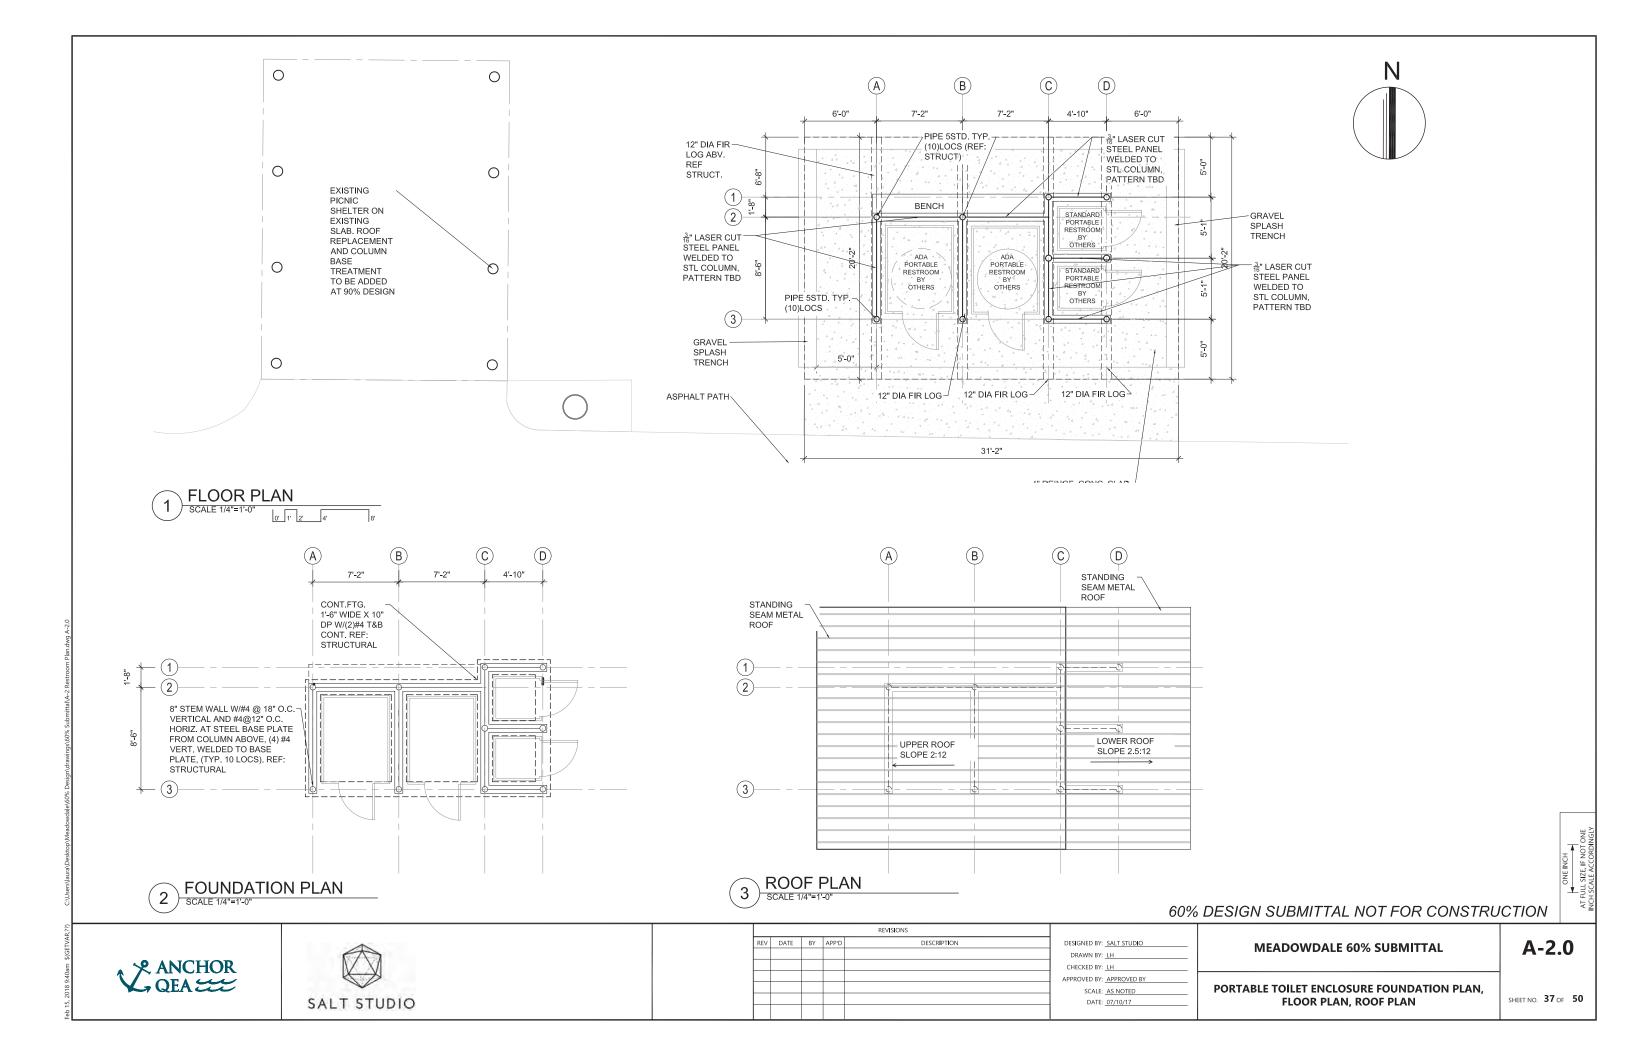





5" DIA. PIPE COLUMN TYP. 5'-0" (3)

5'-1"

STANDARD PORTABLE RESTROOM BY OTHERS STANDARD PORTABLE RESTROOM BY OTHERS

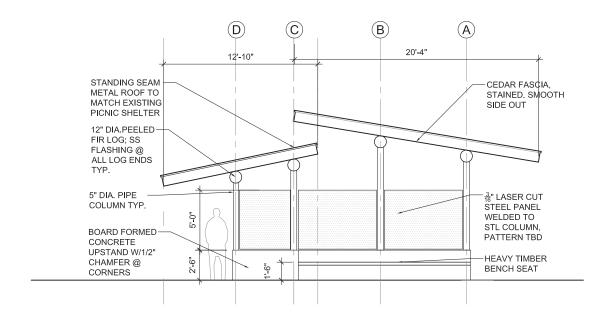

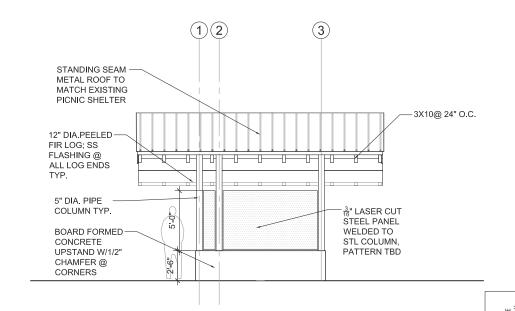

2 1 5'-0"

-3X10@ 24" O.C.

— SS FLASHING W/DRIP EDGE @ ALL BEAM ENDS

-STANDING

@12" O.C.

ENDS

SEAM METAL

ROOF W/RIBS

SS FLASHING

W/DRIP EDGE

BOARD FORMED

UPSTAND W/1/2"

CHAMFER @

CORNERS

@ ALL BEAM

CONCRETE

3 ELEVATION NORTH
SCALE 1/4"=1'-0" 0 1-2 4- 4- 8-

ELEVATION SOUTH

4 ELEVATION WEST

SCALE 1/4"=1'-0"

0 1 2 4 8

60% DESIGN SUBMITTAL NOT FOR CONSTRUCTION

ANCHOR QEA



	REVISIONS										
REV	DATE	BY	APP'D	DESCRIPTION	DES						
					D						
					СН						
					APP						

DESIGNED BY: LH

DRAWN BY: LH

CHECKED BY: LH

APPROVED BY: LH

SCALE: AS NOTED

DATE: <u>02/07/18</u>

MEADOWDALE 60% SUBMITTAL

A-3.0

PORTABLE TOILET ENCLOSURE ELEVATIONS

SHEET NO. 38 OF 50

## 60% DESIGN SUBMITTAL NOT FOR CONSTRUCTION






				REVISIONS	
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					DRA
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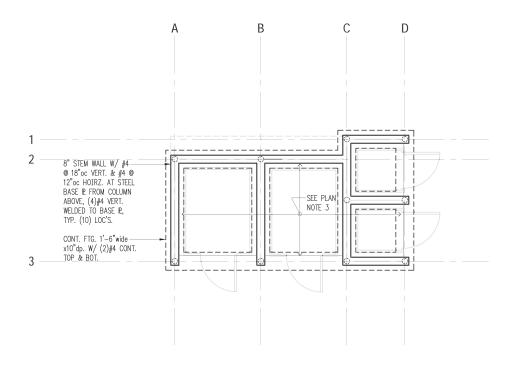
IGNED BY: LDH **MEADOWDALE 60% SUBMITTAL** RAWN BY: LDH, DNW ECKED BY: LDH ROVED BY: \_\_ SCALE: AS NOTED PORTABLE TOILET ENCLOSURE DETAILS

DATE: <u>02/07/18</u>


A-7.0

SHEET NO. 39 OF 50



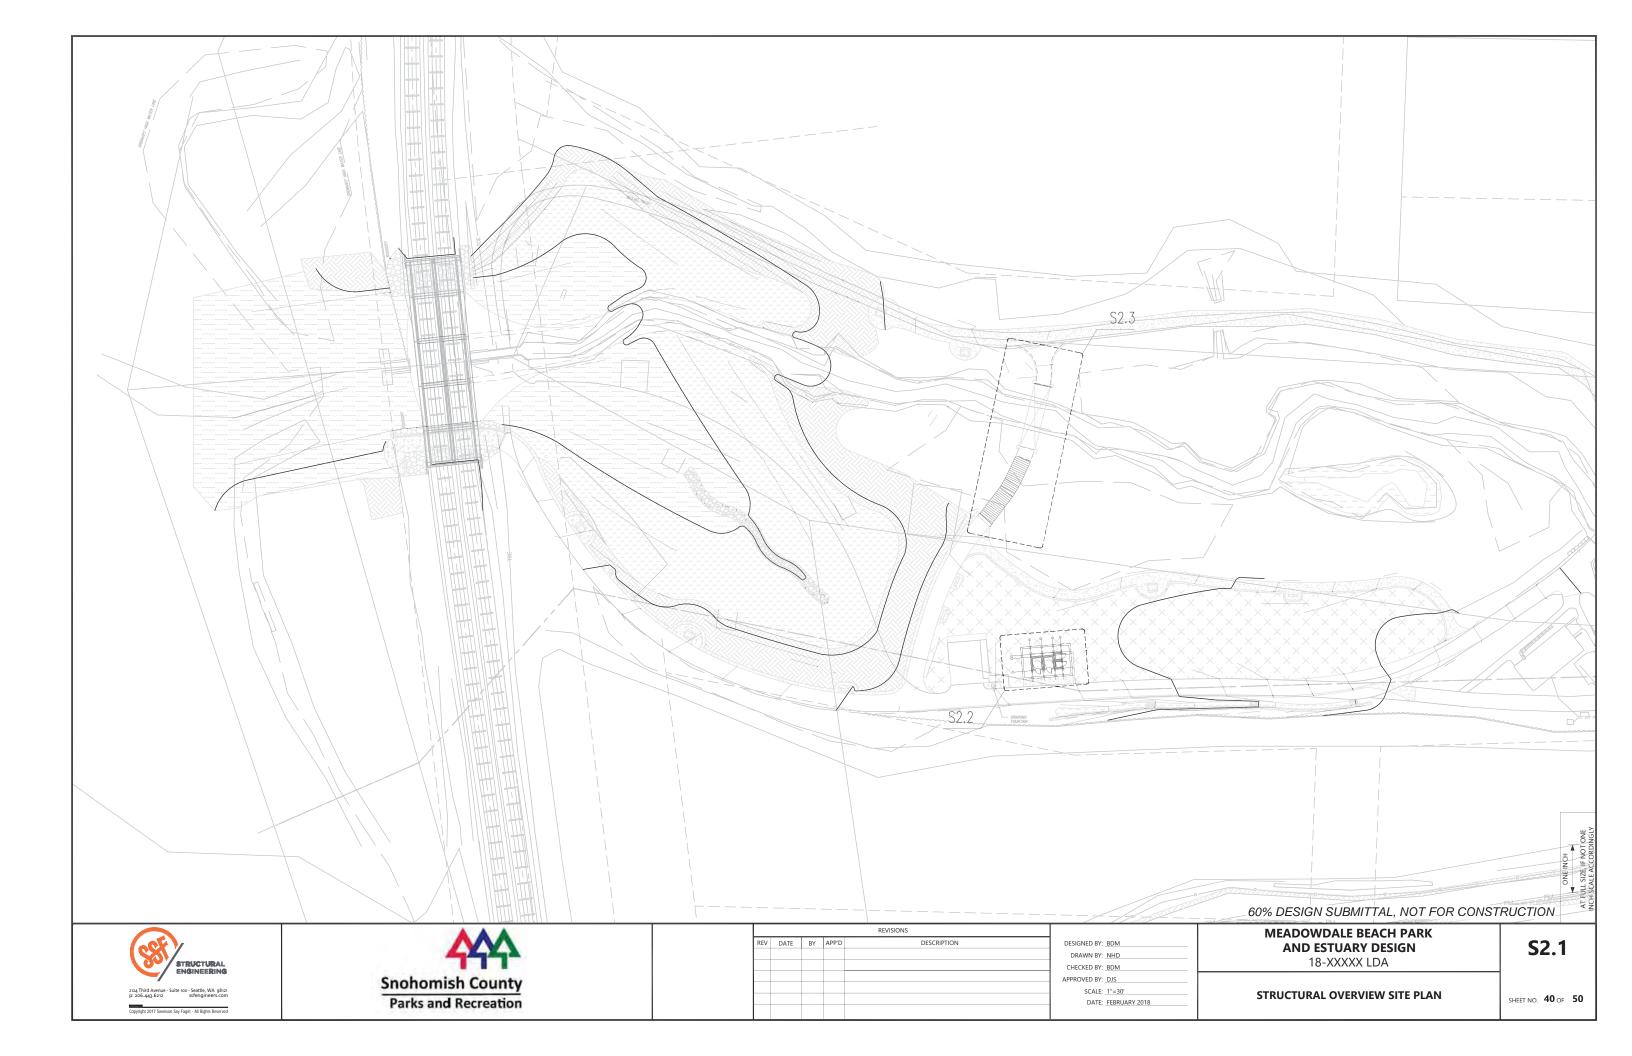

Plan Notes	Legend		Foundation Plan	
DO NOT SCALE DRAWINGS. REFER TO ARCHITECTURAL DRAWINGS FOR ALL DIMENSIONS.		STEM WALL & FOOTING	Scale: 1/4" = 1'-0"	$\mathbb{U}$
2. THE BOTTOM OF ALL EXTERIOR FOOTINGS SHALL BE 18" MINIMUM BELOW EXTERIOR GRADE. BOTTOM OF FOOTINGS		SPAN DIRECTION		
TO ALIGN WITH BOTTOM OF ADJACENT FOOTINGS.  3. INTERIOR SLABS ON GRADE SHALL BE 4" MINIMUM	$\longleftrightarrow \hspace{0.5cm} \longrightarrow$	EXTENTS		
THICKNESS. REINFORCE WITH #3 AT 16" O.C. CENTERED IN SLAB. BELOW SLAB PROVIDE A 10-MIL VAPOR BARRIER OVER 12" MINIMUM FREE DRAINING GRAVEL OVER FIRM NATIVE SOILS OR STRUCTURAL FILL.		HEADER/BEAM PER PLAN		
4. REFER TO GENERAL STRUCTURAL NOTES FOR ADDITIONAL				

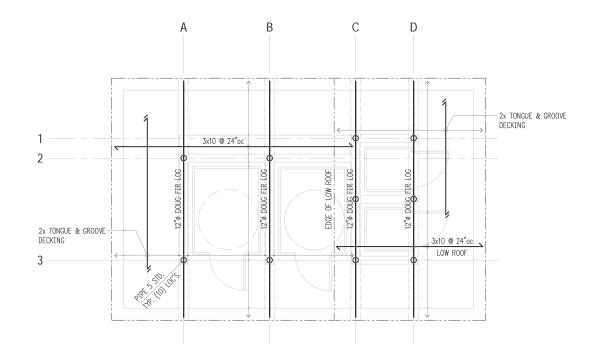

Plan Notes DO NOT SCALE DRAWINGS. REFER TO ARCHITECTURAL DRAWINGS FOR ALL DIMENSIONS.

2. TYPICAL ROOF FRAMING CONSISTS OF ROOFING PER ARCHITECTURAL DRAWINGS OVER 1/2" CDX APA RATED SHEATHING (EXPOSURE 1) OVER 2x TONGUE AND GROOVE DECKING. FACE GRAIN OF PLYWOOD SHEATHING TO BE PERPENDICULAR TO 2x DECKING, U.N.O.

3. NAIL ROOF SHEATHING WITH 8d AT 6"oc AT ALL FRAMED

 NAIL ROUP SHEARHING WITH 80 AT B OC AT ALL FRAMED PANEL EDGES AND AT 12" OC FIELD.

 ALL WOOD HEADERS SHALL BE (2) 2x8, U.N.O.
 PROVIDE AC, ACE, PC, EPC, LPC, OR LCE COLUMN CAP AND BASE AT ALL BEAM TO COLUMN CONNECTIONS U.N.O.
 ALL POSTS SHALL BEAR FULLY ON BEAMS OR POSTS BELOW AND SHALL HAVE FULL CONTINUOUS BEARING THEOLOGY ELONGS TO COUNDATION. THROUGH FLOORS TO FOUNDATION.

7. REFER TO GENERAL STRUCTURAL NOTES FOR ADDITIONAL

REQUIREMENTS.

Roof Framing Plan

Scale: 1/4" = 1'-0" Legend

SPAN & DIRECTION OF FRAMING EXTENTS OF FRAMING HEADER/BEAM PER PLAN STEEL PIPE PER PLAN

60% DESIGN SUBMITTAL, NOT FOR CONSTRUCTION

STRUCTURAL ENGINEERING

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REQUIREMENTS.



REV	DATE	BY	APP'D	DESCRIPTION	DESIGNED BY:	BDM
					DRAWN BY:	NHD
					CHECKED BY:	BDM
					APPROVED BY:	DJS
					SCALE:	
					DATE:	FEBRUARY 2018

NHD BDM : DJS

18-XXXXX LDA


**S2.2** 

**TOILET ENCLOSURE STRUCTURAL PLANS** 

**MEADOWDALE BEACH PARK** 

**AND ESTUARY DESIGN** 

SHEET NO. **41** OF **50** 

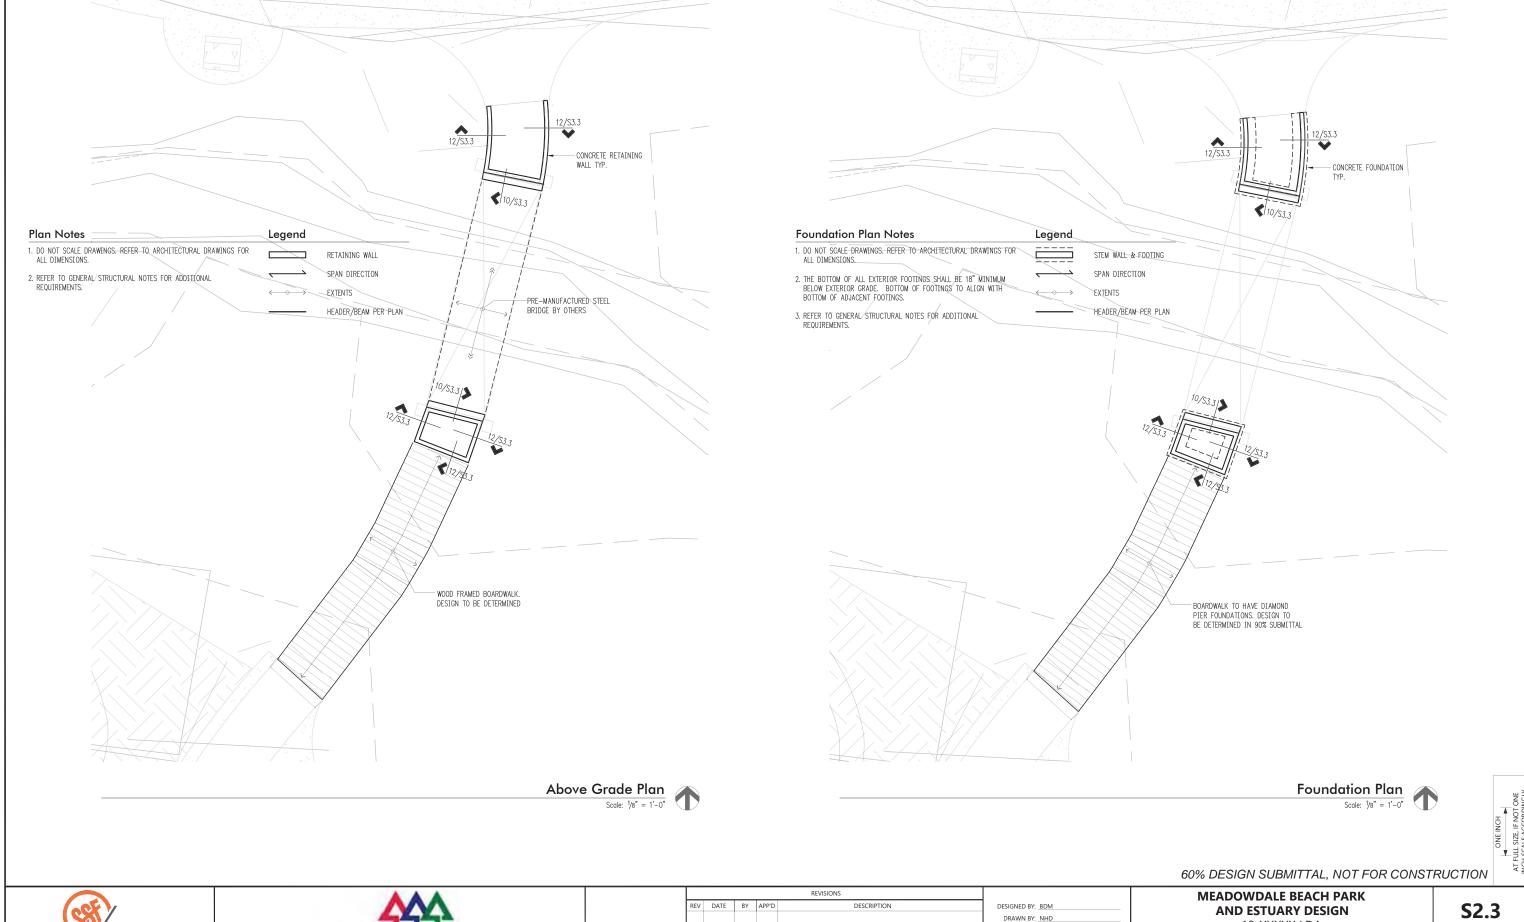

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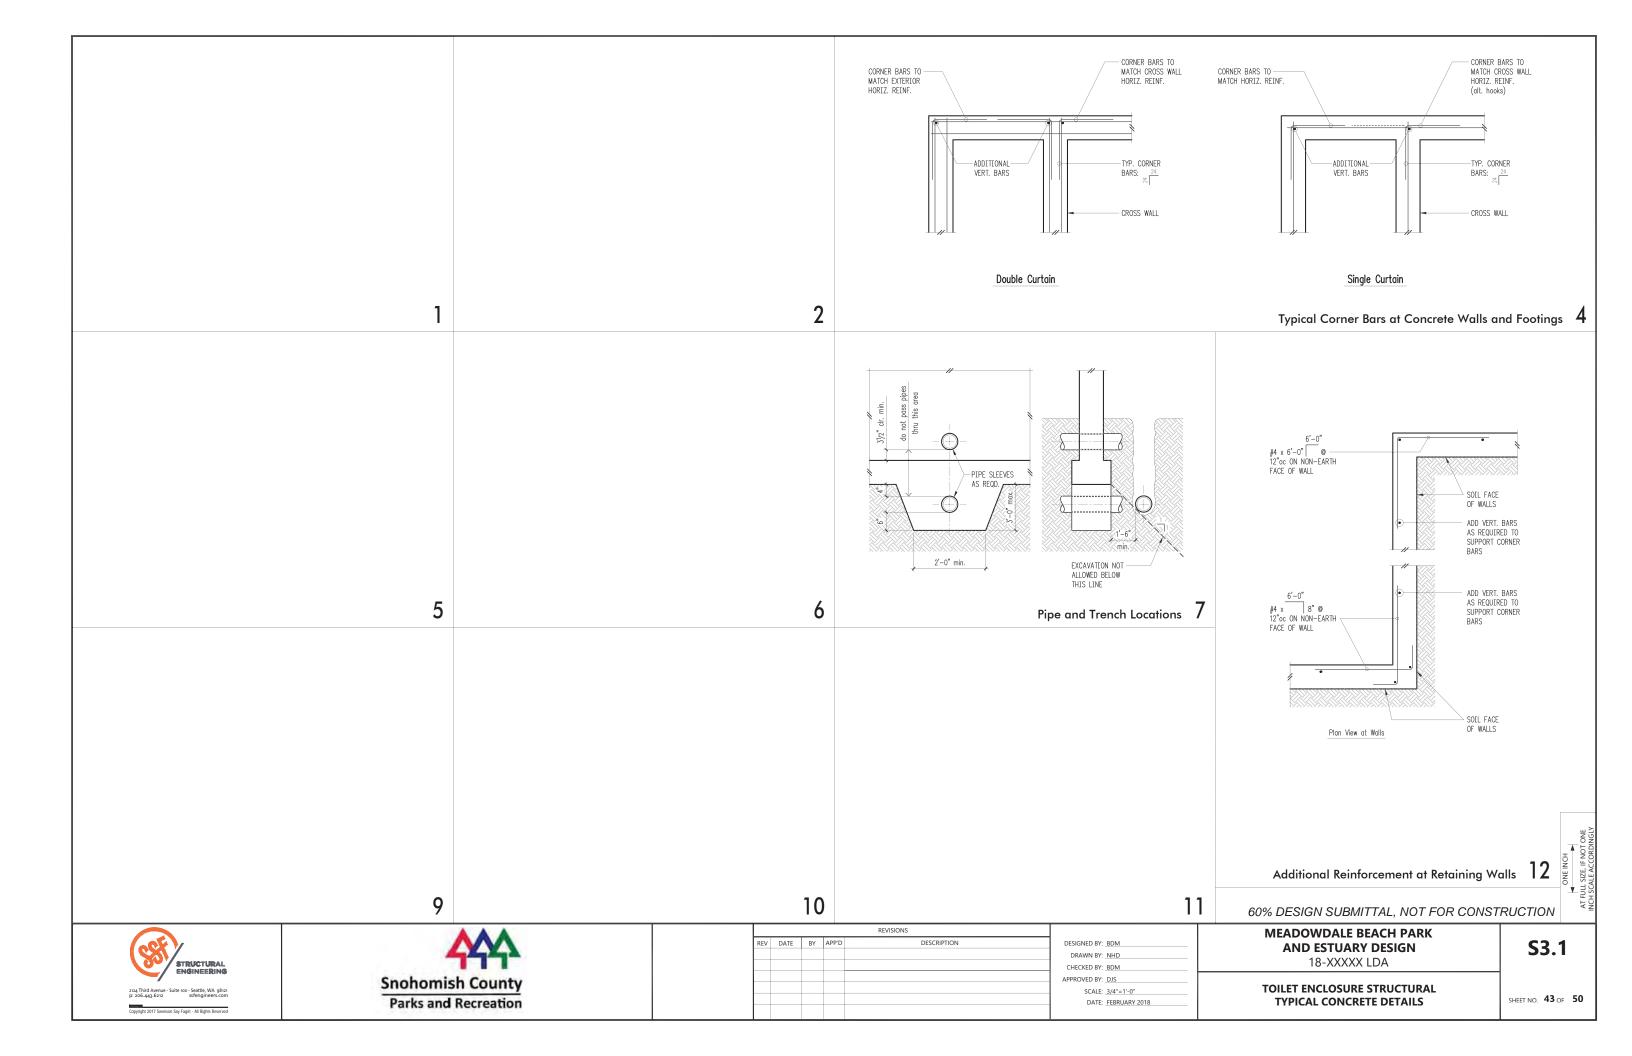



REV	DATE	BY	APP'D	DESCRIPTION	DESIGNED BY:	BDM
					DRAWN BY:	NHD
					CHECKED BY:	BDM
					APPROVED BY:	DJS
					SCALE:	1/8"=1'-0"
					DATE:	FEBRUARY 2018


18-XXXXX LDA

PEDESTRIAN BRIDGE ABUTMENT AND **BOARDWALK PLANS** 

SHEET NO. 42 OF 50




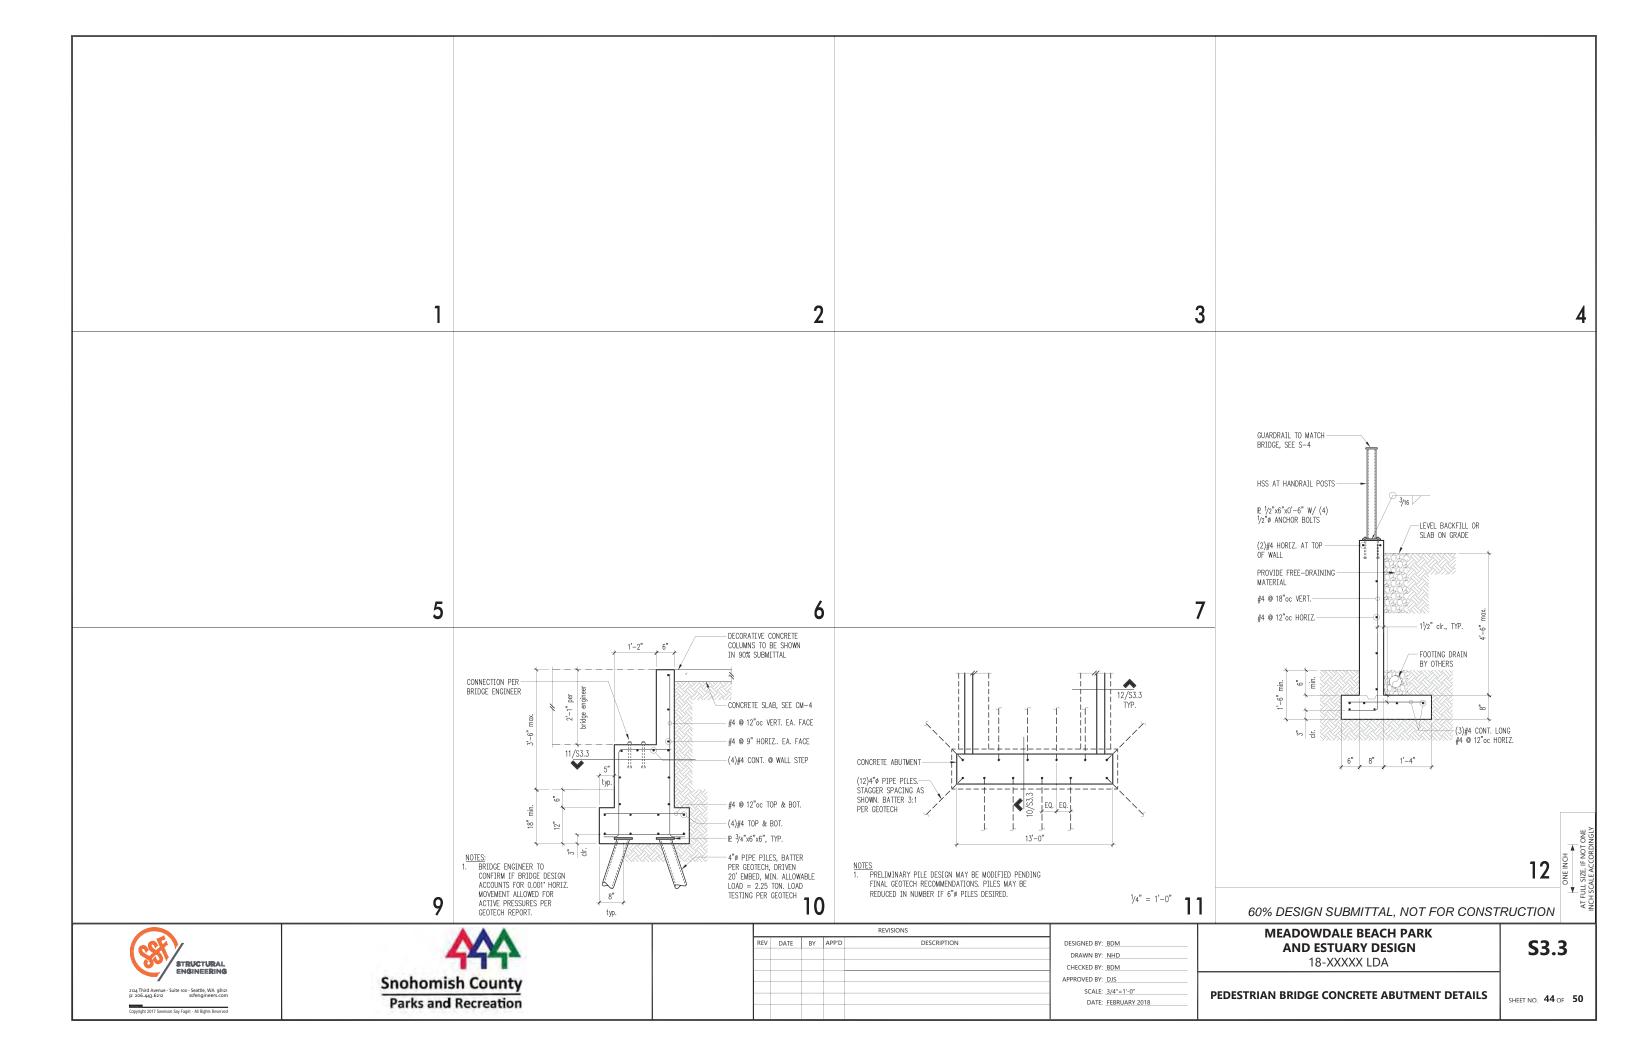

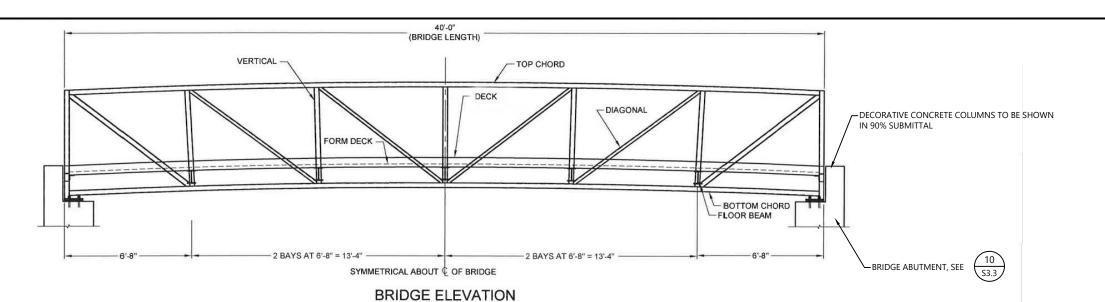

## **GENERAL NOTES**

- 1. DESIGN STRESSES ARE IN ACCORDANCE WITH "STANDARD SPECIFICATION FOR HIGHWAY BRIDGES" & "GUIDE SPECIFICATIONS FOR DESIGN OF PEDESTRIAN BRIDGES" BY THE AMERICAN ASSOCIATION OF STATE HIGHWAY AND TRANSPORTATION OFFICIALS (AASHTO), 2009.
- 2. BRIDGE MEMBERS ARE FABRICATED FROM HIGH STRENGTH, LOW ALLOY, ENHANCED ATMOSPHERIC CORROSION RESISTANT ASTM A847 COLD-FORMED WELDED SQUARE AND RECTANGULAR TUBING, AND ASTM A588, ASTM A606, OR ASTM A242 PLATE AND STRUCTURAL SHAPES (Fv=50,000 PSI)
- 3. CONCRETE DECK: GALVANIZED FORM DECK SUPPLIED BY CONTECH CONCRETE, REINFORCING, AND EXPANSION MATERIAL SUPPLIED BY OTHERS. SEE CONCRETE DECK SHEET
- 4. THE GAS METAL ARC WELDING PROCESS OR FLUX CORED ARC WELDING PROCESS WILL BE USED. WELDING TO BE IN ACCORDANCE WITH AWS D1.1.
- 5. ALL TOP AND BOTTOM CHORD SHOP SPLICES TO BE COMPLETE PENETRATION TYPE WELDS. WELD BETWEEN TOP CHORD AND END VERTICAL SHALL BE AS
- 6. UNLESS OTHERWISE NOTED, WELDED CONNECTIONS SHALL BE FILLET WELDS (OR HAVE THE EFFECTIVE THROAT OF A FILLET WELD) OF A SIZE EQUAL TO THE THICKNESS OF THE LIGHTEST GAGE MEMBER IN THE CONNECTION. WELDS SHALL BE APPLIED AS FOLLOWS:
  - A BOTH ENDS OF VERTICALS, DIAGONALS, AND FLOOR BEAMS SHALL BE WELDED ALL AROUND.
  - B. BRACE DIAGONALS WILL BE WELDED ALL AROUND.
  - C.MISCELLANEOUS NON-STRUCTURAL MEMBERS WILL BE STITCH WELDED TO
- 7. BRIDGE DESIGN WAS ONLY BASED ON COMBINATIONS OF THE FOLLOWING LOADS WHICH WILL PRODUCE MAXIMUM CRITICAL MEMBER STRESSES.
  - A 90 PSF UNIFORM LIVE LOADING ON THE FULL DECK AREA OR ONE 10,000 LB VEHICLE LOAD. THE LOAD SHALL BE DISTRIBUTED AS A FOUR-WHEEL VEHICLE WITH 80% OF THE LOAD ON THE REAR WHEELS. THE WHEEL TRACK WIDTH OF THE VEHICLE SHALL BE 6'-0" AND THE WHEEL BASE SHALL BE 10'-0". THE VEHICLE SHALL BE POSITIONED SO AS TO PRODUCE THE MAXIMUM STRESSES IN EACH MEMBER, INCLUDING DECKING.
- B. 35 PSF WIND LOAD ON THE FULL HEIGHT OF THE BRIDGE, AS IF ENCLOSED. C.20 PSF UPWARD FORCE APPLIED AT THE WINDWARD QUARTER POINT OF THE TRANVERSE BRIDGE WIDTH (AASHTO 3,15.3)
- 8. CLEANING: ALL EXPOSED SURFACES OF STEEL SHALL BE CLEANED IN ACCORDANCE WITH STEEL STRUCTURES PAINTING COUNCIL SURFACES PREPARATION SPECIFICATIONS NO. 7 BRUSH-OFF BLAST CLEANING. SSPC-SP7-LATEST EDITION.
- 9. MINIMUM MATERIAL THICKNESS OF 1/4" ON ALL STRUCTURAL MEMBERS.

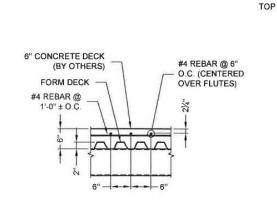


TYP SLAB REINFORCEMENT DETAIL fc = 3.500 PSI (MINIMUM 28 DAY STRENGTH)

GRADE 60 REINFORCING (fy = 60,000 PSI)

COMBINE REACTIONS AS PER LOCAL OR GOVERNING BUILDING CODES AS REQUIRED

BRIDGE REACTIO	+ DOWNWARD LOAD - UPWARD LOAD			
	P (LBS)	H (LBS)	L (LBS)	
DEAD LOAD (2)	8,300			
UNIFORM LIVE LOAD	9,000			
VEHICLE LOAD	5,000			
WIND UPLIFT WINDWARD 20 PSF LEEWARD	-3,150 -1,050			
WIND	±1,185	3,910		
THERMAL (2)			1,245	

- "P" VERTICAL LOAD EACH BASE PLATE (4 PER BRIDGE) "H" - HORIZONTAL LOAD EACH FOOTING (2 PER BRIDGE) "L" - LONGITUDINAL LOAD EACH BASE PLATE (4 PER BRIDGE)
- (1) BRIDGE LIFTING WEIGHT: 8,800 LBS
- ② BRIDGE FINAL WEIGHT: 33,200 LBS
  - 1) DOES NOT INCLUDE WEIGHT OF CONCRETE DECK
  - 2 INCLUDES WEIGHT OF CONCRETE DECK

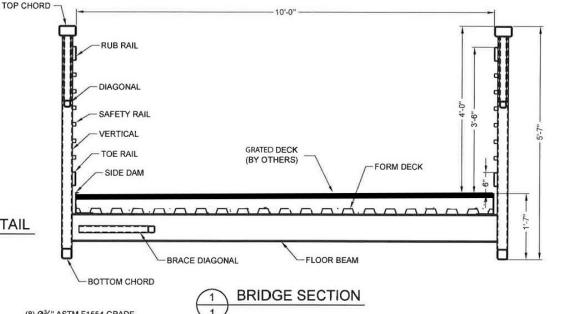

(8) Ø3/4" ASTM F1554 GRADE 36 GALV. ANCHOR RODS W/(2) NUTS AND (1) 2" O.D. WASHER EACH. (BY OTHERS) (BACKWALL TO BACKWALL) 21/3 CHECK DIAGONAL MEASUREMENT TO **VERIFY SQUARENESS** ANCHOR BOLT ELEVATION 38'-6" - ( INSIDE BOLT TO C INSIDE BOLT)

DATE: FEBRUARY 2018

60% DESIGN SUBMITTAL. NOT FOR CONSTRUCTION





REV	DATE	BY	APP'D	DESCRIPTION	DESIGNED BY:	OTHERS
					DRAWN BY:	MD/CH/TG
					CHECKED BY:	BS
					APPROVED BY:	PH
					SCALE:	AS NOTED
					DATE:	FEBRUARY 2
	•	•	•			

PLAN


**MEADOWDALE BEACH PARK AND ESTUARY DESIGN** 


18-XXXXX LDA

PEDESTRIAN BRIDGE DETAIL

S-4

SHEET NO. 45 OF 50

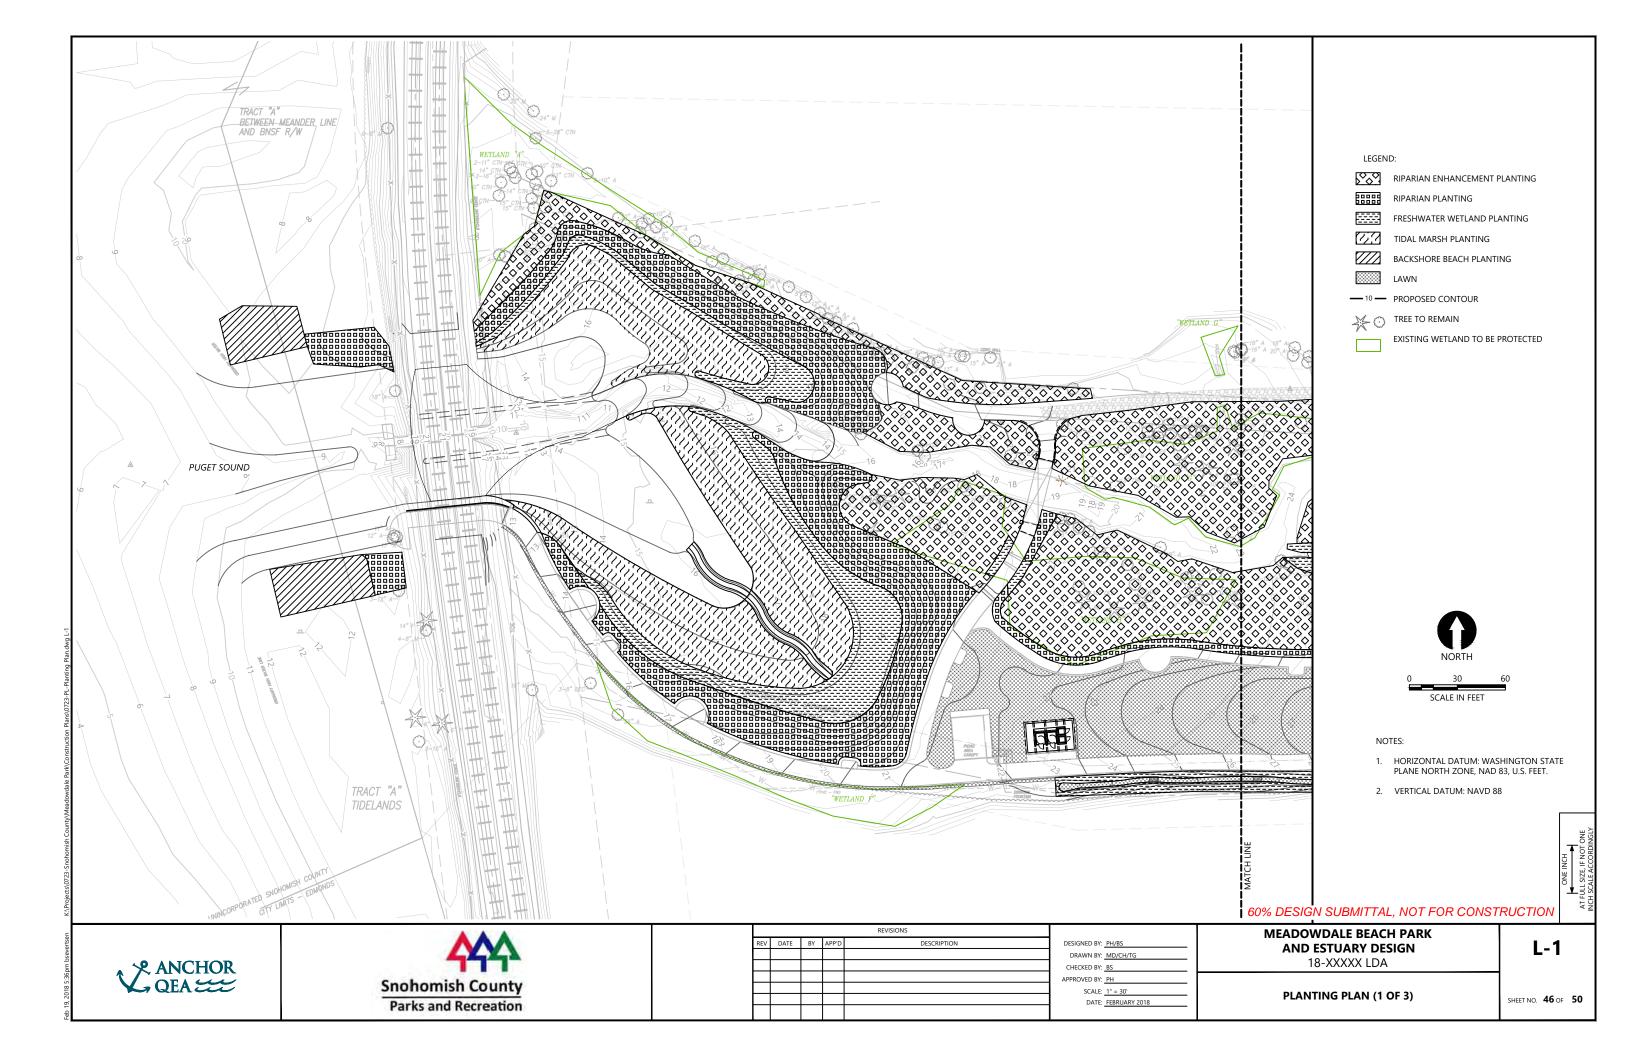

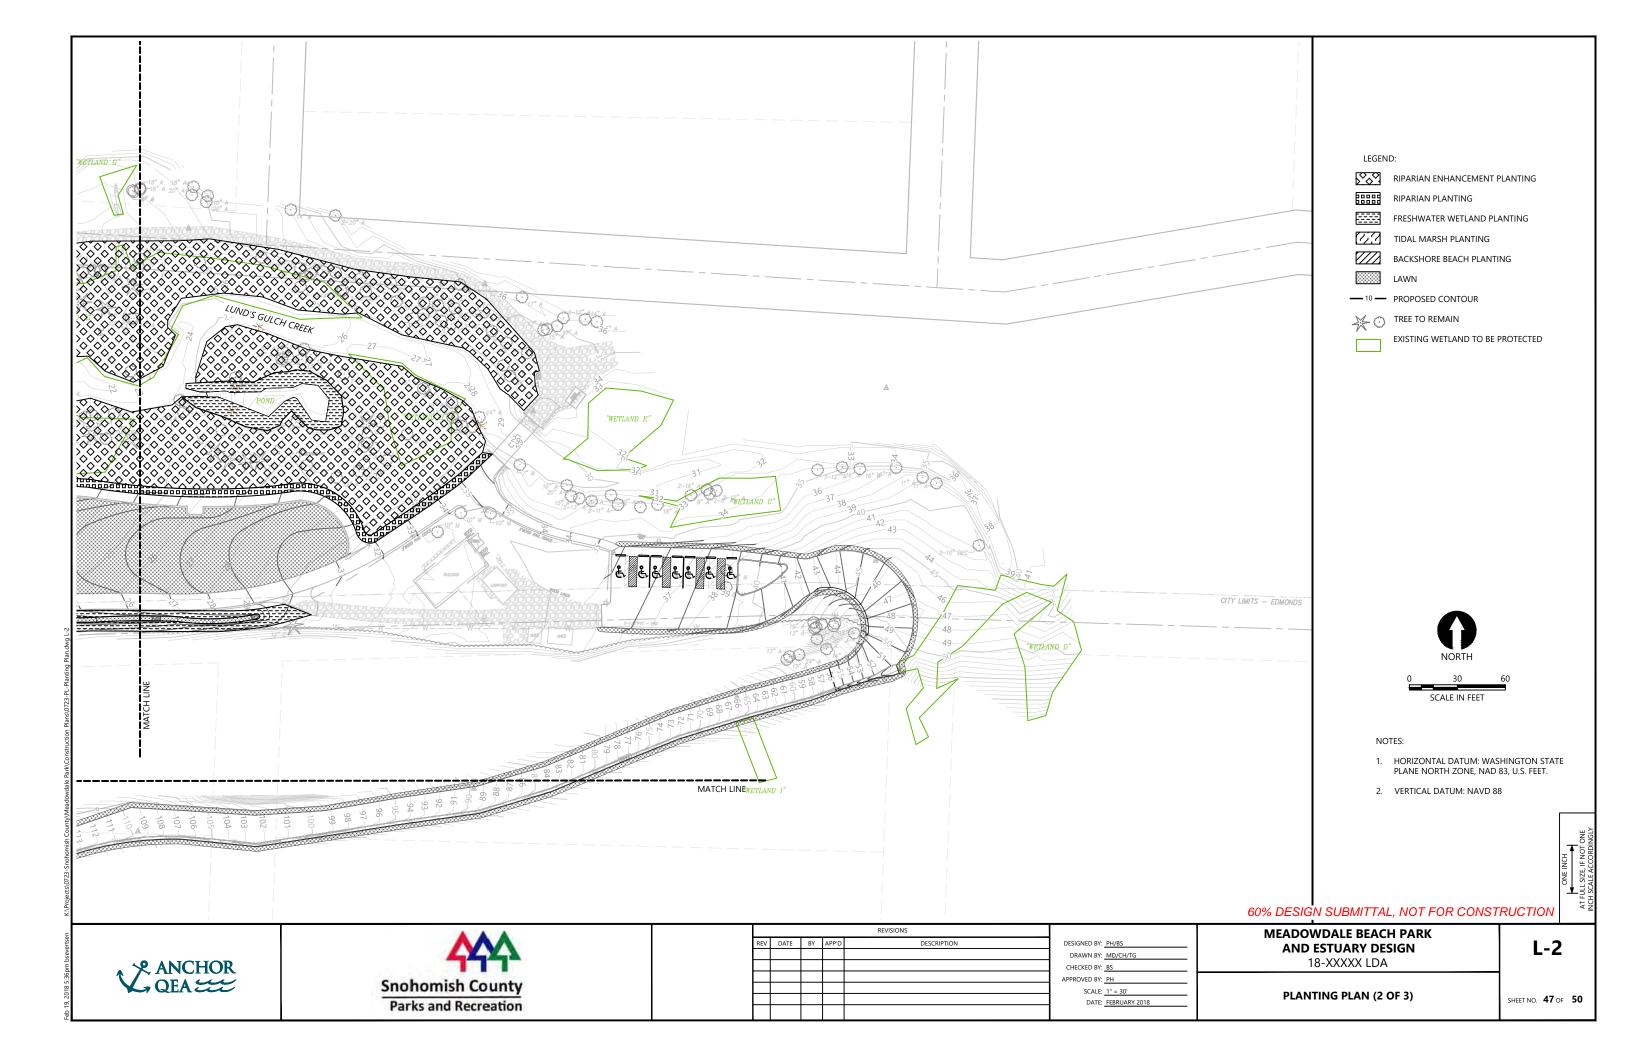



## NOTES:


- HORIZONTAL DATUM: WASHINGTON STATE PLANE NORTH ZONE, NAD 83, U.S. FEET.
- 2. VERTICAL DATUM: NAVD 88

SYMBOL	COMMON NAME	SPECIES NAME	SIZE	SPACING	REMARKS	DETAIL
		RIPARIAN ENH	IANCEMEN	IT		
TREES						
	Sitka Spruce	Picea sitchensis	5 gal.	30' O.C.	Evergreen	
	Western Red Cedar	Thuja Plicata	5 gal.	30' O.C.	Deciduous	(188)
	Western Hemlock	Tsuga heterophylla	5 gal.	30' O.C.	Evergreen, moist deep soil	\L-4/
		RIPAR	IAN	•	•	
TREES						
	Big-leaf Maple	Acer macrophyllum	5 gal.	12' O.C.	Deciduous	
	Red Alder	Alnus rubra	5 gal.	12' O.C.	Deciduous	1
	Oregon Crabapple	Malus fusca	5 gal.	12' O.C.	Deciduous	1
	Sitka Spruce	Picea sitchensis	5 gal.	12' O.C.	Evergreen	1
	Shore Pine	Pinus contorta var. "contorta"	5 gal.	12' O.C.	Evergreen, Full sun	1 (188)
	Douglas-Fir	Pseudotsuga menziesii	5 gal.	12' O.C.	Evergreen, Full sun	1 L-4 /
	Hooker Willow	Salix hookeriana	5 gal.	12' O.C.	Deciduous	$1 \smile$
	Scouler Willow	Salix scouleriana	5 gal.	12' O.C.	Deciduous	1
	Western Hemlock	Tsuga heterophylla	5 gal.	12' O.C.	Evergreen, moist deep soil	1
	Western Red Cedar	Thuja Plicata	5 gal.	12' O.C.	Evergreen	1
SHRUBS		•				
	Vine Mape	Acer circinatum	2 gal.	6' O.C.	Deciduous	
	Saskatoon Serviceberry	Amelanchier alnifolia	2 gal.	6' O.C.	Deciduous	1
	Redosier Dogwood	Cornus sericea	2 gal.	6' O.C.	Deciduous	1
	Beacked Hazelnut	Corylus cornuta	2 gal.	6' O.C.	Deciduous	1
	Oceanspray	Holodiscus discolor	2 gal.	6' O.C.	Deciduous	1
	Tall Oregon Grape	Mahonia aquifolium	2 gal.	6' O.C.	Evergreen	1
	Indian Plum	Oemleria cerasiformis	2 gal.	6' O.C.	Deciduous	188
	Pacific Ninebark	Physocarpus capitatus	2 gal.	6' O.C.	Deciduous	L-4/
	Nootka Rose	Rosa nutkana	2 gal.	6' O.C.	Deciduous	
	Thimbleberry	Rubus parviflorus	2 gal.	6' O.C.	Deciduous	
	Red Elderberry	Sambucus racemosa	2 gal.	6' O.C.	Deciduous	
	Common Snowberry	Symphoricarpos albus	2 gal.	6' O.C.	Deciduous	1
GROUND	COVERS					
	Vanilla-leaf	Achlys triphylla	1 gal.	4' O.C.	Deciduous	
	Wild Ginger	Asarum caudatum	1 gal.	4' O.C.	Deciduous	
	Salal	Gaultheria shallon	1 gal.	4' O.C.	Evergreen	] (3&8)
	Low Oregon Grape	Mahonia nervosa	1 gal.	4' O.C.	Evergreen	] 🛂
	Swordfern	Polystichum munitum	1 gal.	4' O.C.	Evergreen	7

		FRESHWATER	WETLAND			
	TREES					/18
	Black Hawthorn	Crataegus douglasii	5 gal.	12' O.C.	Deciduous	\_L-
	Hooker Willow	Salix hookeriana	livestake	3' O.C.	Deciduous	${}$
	Scouler Willow	Salix scouleriana	livestake	3' O.C.	Deciduous	
	SHRUBS					
	Redosier Dogwood	Cornus sericea	2 gal.	6' O.C.	Deciduous	
	Black Twinberry	Lonicera involucrata	2 gal.	6' O.C.	Deciduous	(18
	Salmonberry	Rubus spectabilis	2 gal.	6' O.C.	Deciduous	
	EMERGENT	•	•			·
	Slough Sedge	Carex obnupta	10-in plug	2' O.C.	Deciduous	
	Darkthroat shooting star	Dodecatheon pulchellum	10-in plug	2' O.C.	Deciduous	
	Skunk Cabbage	Lysichiton americanus	10-in plug	2' O.C.	Deciduous	
	Small fruited Bulrush	Scirpus microcarpus	10-in plug	2' O.C.	Deciduous	$\frac{48}{1}$
	Hardstem Bulrush	Schoenoplectus acutus	10-in plug	2' O.C.	Deciduous, Full sun	
	American Three-square	Scirpus americanus	10-in plug	2' O.C.	Deciduous	
	Piggy-back plant	Tolmiea menziesii	10-in plug	2' O.C.	Deciduous	
	•	TIDAL MA	ARSH	•	•	•
//	EMERGENT					
	Douglas Aster	Aster subspicatus	10-in plug	2' O.C.	Deciduous	
	Lyngby's Sedge	Carex lyngbyei	10-in plug	2' O.C.	Deciduous	$\neg$
	Tufted Hairgrass	Deschampsia cespitosa	10-in plug	2' O.C.	Deciduous	(48
	Puget Sound Gumweed	Grindelia integrifolia	10-in plug	2' O.C.	Deciduous	一 (Ŀ
	Pacific Silverweed	Potentilla anserina ssp. Pacifica	10-in plug	2' O.C.	Deciduous	
	American Three-square	Scirpus americanus	10-in plug	2' O.C.	Deciduous	
	Henderson's Checker-bloom	Sidalcea hendersonii	10-in plug	2' O.C.	Deciduous	
	'	BACKSHORE	BEACH		•	
7	EMERGENT					
_	Coastal sand verbena	Abronia latifolia	10-in plug	2' O.C.	Deciduous	
	Sea thrift	Armeria maritima	10-in plug	2' O.C.	Deciduous	(48
	Coastal Strawberry	Fragaria chiloensis	10-in plug	2' O.C.	Evergreen	コビ
	Puget Sound Gumweed	Grindelia integrifolia	10-in plug	2' O.C.	Deciduous	
	Dunegrass	Leymus mollis	Bare root	2' O.C.	Deciduous	<b>─</b> \\ \tau
88	LAWN	•		•		
		See Specifications			1	

60% DESIGN SUBMITTAL, NOT FOR CONSTRUCTION



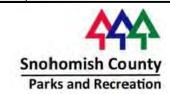

I	REVISIONS								
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I						CHE			
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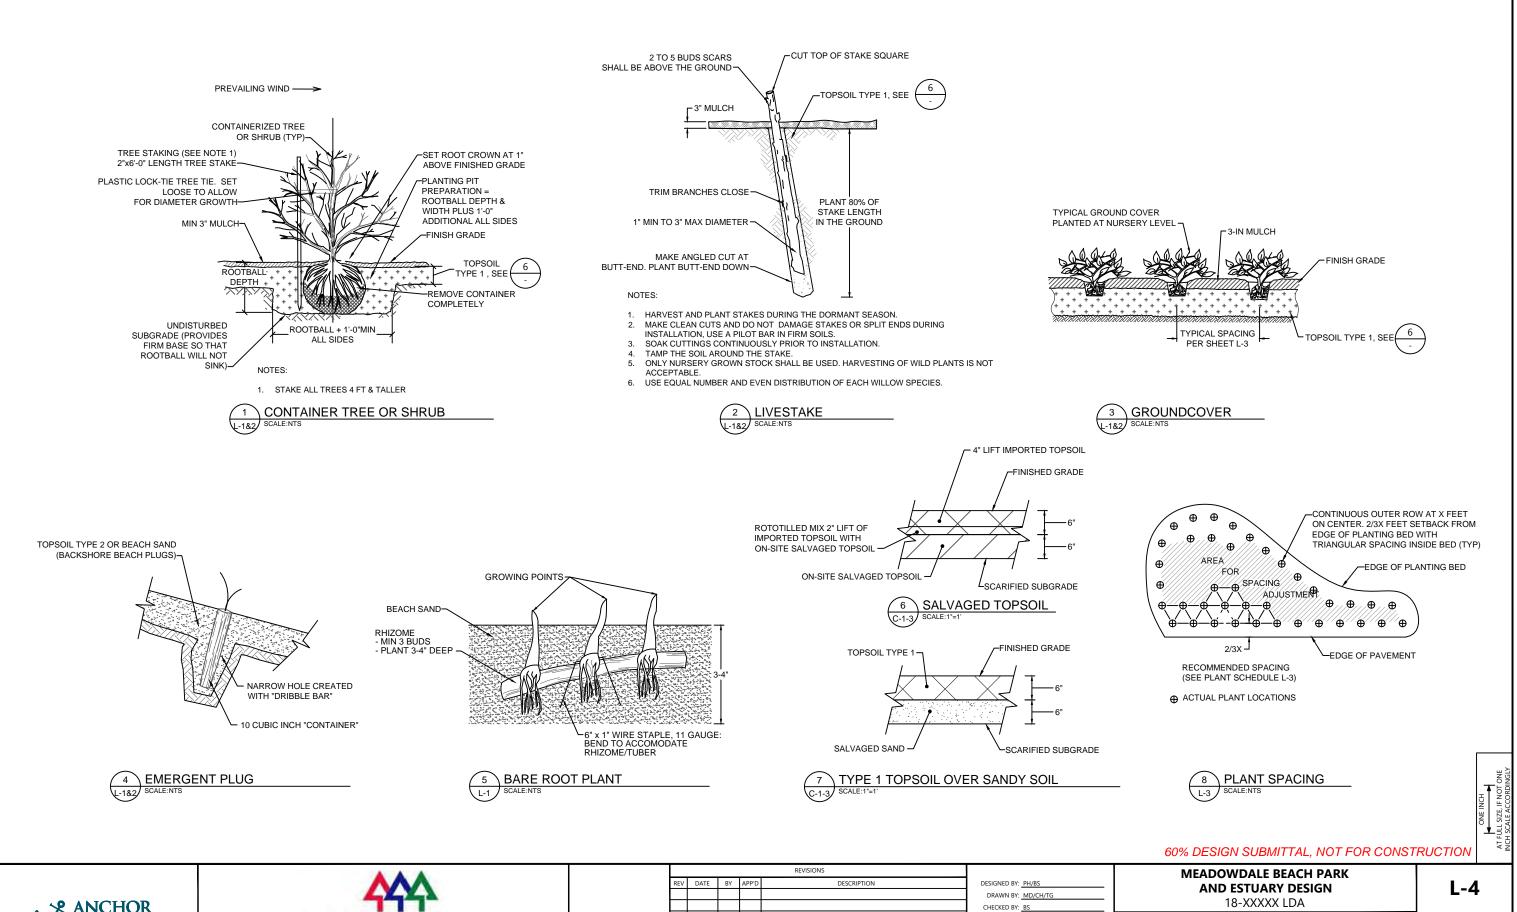
DESIGNED BY:	PH/BS	
DRAWN BY:	MD/CH/TG	
CHECKED BY:	BS	
APPROVED BY:	PH	
SCALE:	1" = 30'	
DATE:	FEBRUARY 2018	

MEADOWDALE BEACH PARK AND ESTUARY DESIGN 18-XXXXX LDA

PLANTING PLAN (3 OF 3)

L-3

SHEET NO. 48 OF 50



APPROVED BY: PH

SCALE: AS NOTED

DATE: FEBRUARY 2018

**PLANTING DETAILS** 

SHEET NO. 49 OF 50

reb 19, 2010 5:30pm bseve

Snohomish County

Parks and Recreation